



Administrative Office of the Courts

Operations Division

Amendment #2
Request for Proposals
Project K20-0065-40
District Court Glen Burnie Video Surveillance System

This Amendment is being issued to amend and clarify certain information contained in the above-named RFP. All information contained herein is binding on all Offerors who respond to this RFP. Specific parts of the RFP have been amended. The following changes/additions are listed below; new language has been underlined (ex. new language) and language deleted has been marked with a strikethrough (ex. ~~language deleted~~).

1. Modify Attachment E-Price proposal Form

ATTACHMENT E – PRICE PROPOSAL FORM

PRICE PROPOSAL FOR RFP # K20-0065-40

Description of Proposed Video Surveillance System	Video Surveillance System Cost	Intercom system Cost	Access Control Cost	Total Amount
1st Floor Area				\$
2nd Floor Area				\$
3 rd Floor Area – Existing				\$
Total Proposed Price				\$


<u>Description of Proposed Video Surveillance System</u>	<u>Qty</u>	<u>Price (\$)</u>
<u>Indoor Fixed Cameras</u>	<u>38</u>	
<u>Outdoor Fixed Cameras</u>	<u>13</u>	
<u>Outdoor PTZ Cameras</u>	<u>2</u>	
<u>Monitors, workstations and peripherals</u>	<u>4</u>	
<u>NVR(s) and associated equipment to include Racks, patch panels etc.</u>	<u>n/a</u>	
<u>Access Control</u>	<u>n/a</u>	
<u>Intercom System</u>	<u>n/a</u>	
<u>Labor</u>	<u>n/a</u>	
<u>2 years warranty</u>	<u>n/a</u>	
<u>Total.....</u>		

2. **Attachment J: Additional Drawings (Included)**


Issued by: Sejal Lakhawala

Procurement Officer

January 31, 2020

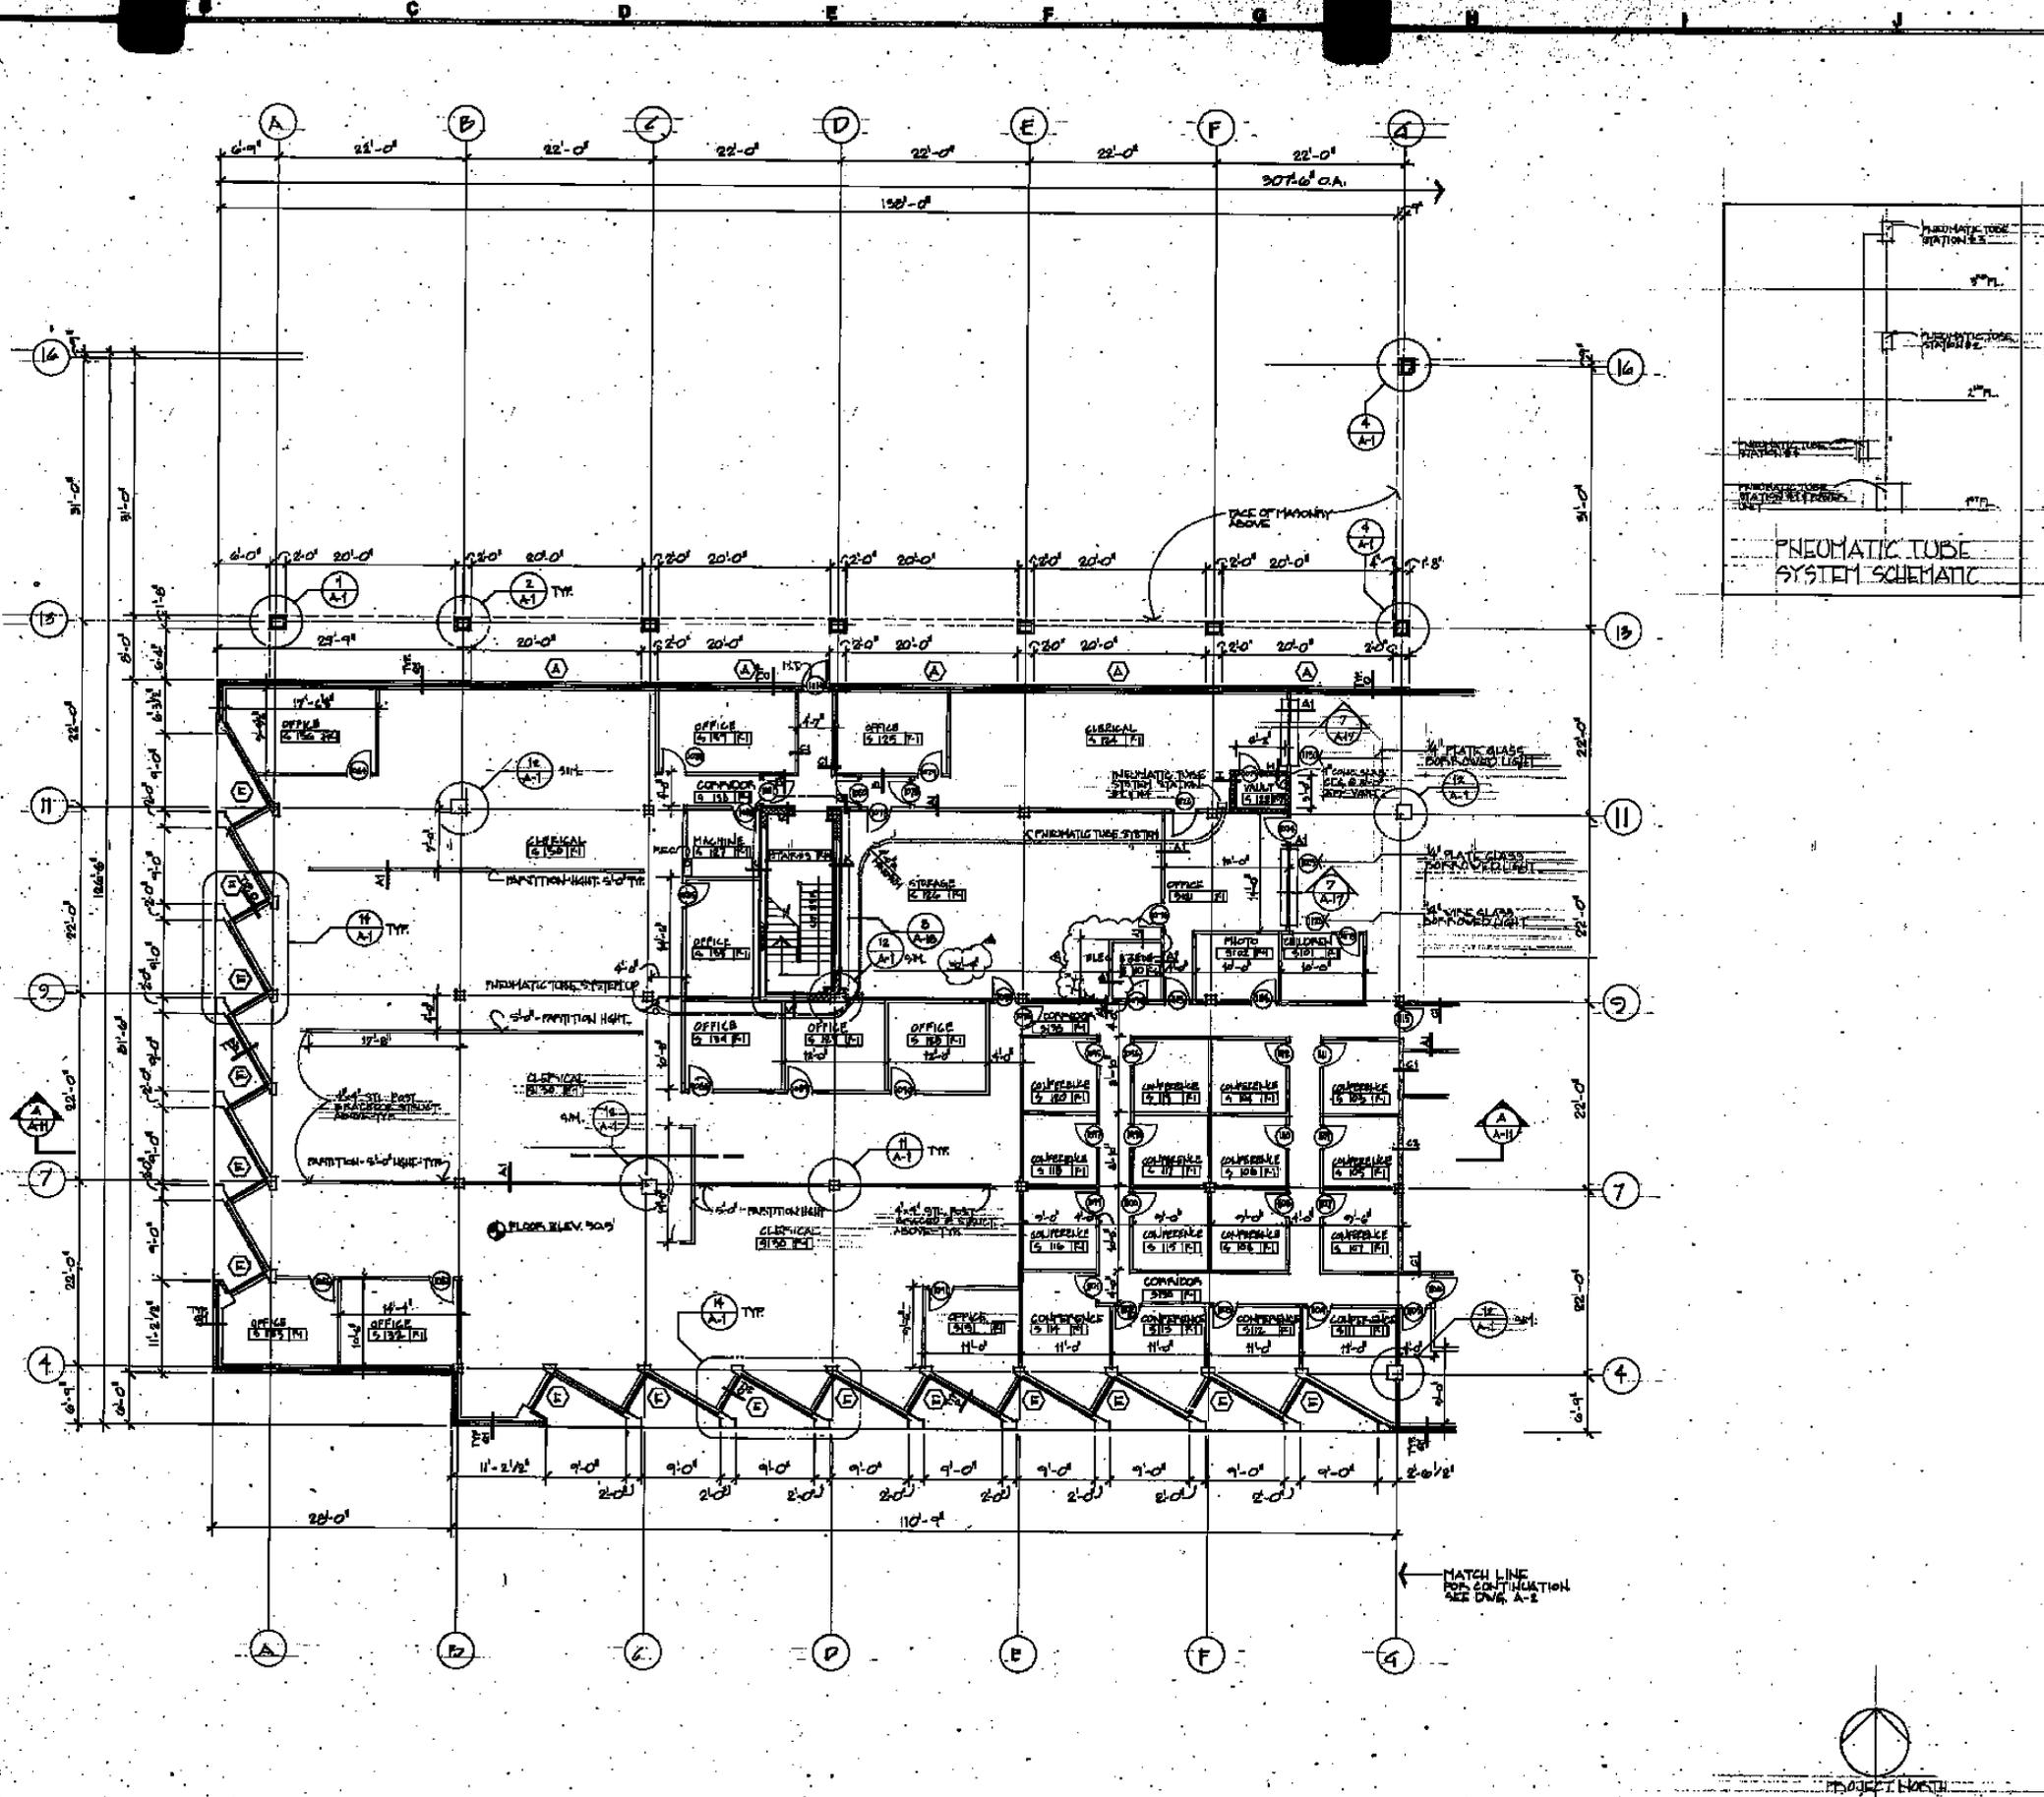

WALL CONSTRUCTION SCHEDULE

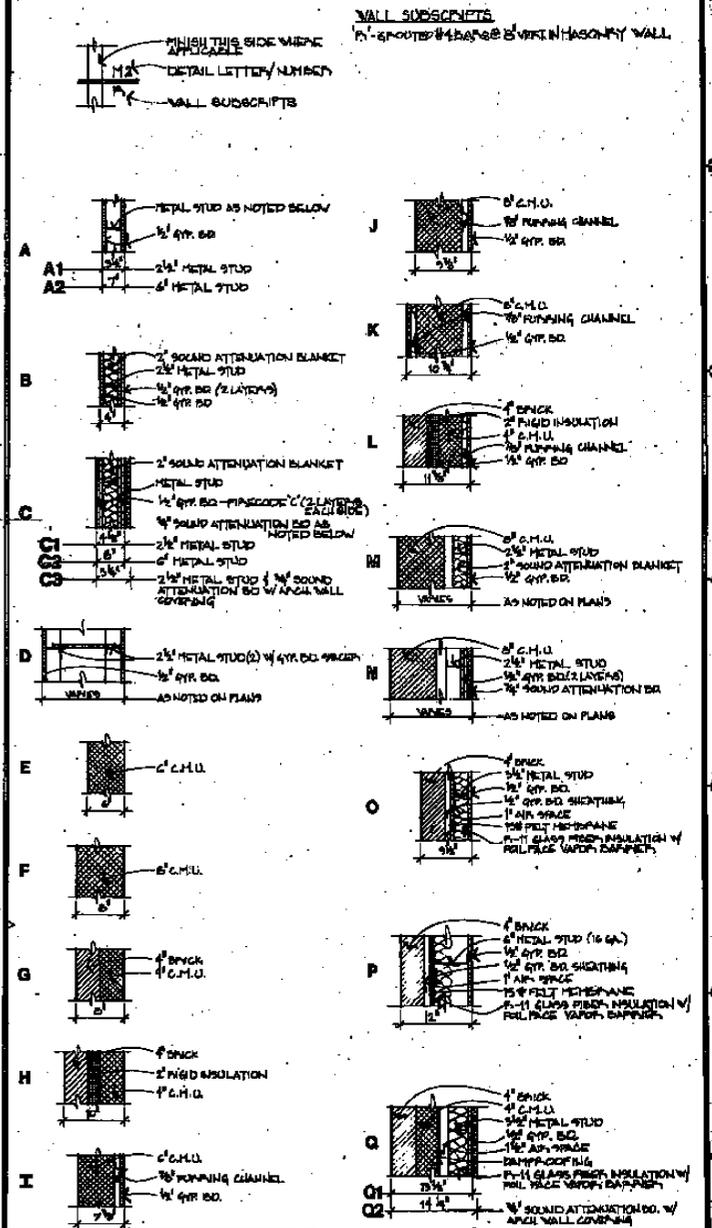

FINISH SCHEDULE

FINISH NO.	F1	F2	F3	F4	F5	F6	F7	F8	F9	F10	F11	F12
FLOORS	CARPET	C.P.	SEAL NR	CERAMIC MOSAIC	CERAMIC MOSAIC	CONC.	CONC. NOTES	CONC.	CARPET	V.A.T.	CARPET	
BASE	VINYL	C.P.		CERAMIC MOSAIC	CERAMIC MOSAIC	VINYL	5" PAINT	5" BRN PAINTED	VINYL	VINYL	VINYL	
WALLS	PLASTER	C.P.	C.P.	C.P.	VVVC	PAINT	PAINT	FRONT PAINTED	NOTE 1	FRONT PAINTED	VVVC	
Ceilings	2 1/2" G.Y.R. BO.	NOTES	NOTES	PTD. G.Y.R. BO.	PTD. G.Y.R. BO.	2 1/2" G.Y.R. BO.	NOTES	FRONT PAINTED	FRONT PAINTED	2 1/2" G.Y.R. BO.	2 1/2" G.Y.R. BO.	
DETAILS									FRONT PAINTED	FRONT PAINTED	FRONT PAINTED	

FINISH NOTES

- SEE 1/4" - 1'-0" PLANS & ELEVATIONS FOR FINISHES
- CERAMIC WALL TILE FULL HEIGHT ON PHOTO WALL ONLY; VINYL WALL COVERING ON OTHER WALLS - SEE PLAN
- SEE DRAWING AT #1 FOR FINISHES
- 2 LAYERS OF 1/2" G.Y.R. BO. OVER VVVC OR PLASTER
- TRAFFIC DECK COVERING & PENTHOUSE FLOORS

ABBREVIATIONS: S.A.T. - SOFT ACOUSTICAL TILE; C.T. - CERAMIC TILE; V.A.T. - VINYL ASBESTOS TILE; C.P. - CERAMIC PAINTS; VVVC - VINYL WALL COVERING

GENERAL NOTES

- ALL VERTICAL DIM. TAKEN TO 4" FROM UPPER FACE OF METAL STUD
- ALL HORIZONTAL DIM. TAKEN TO 4" FROM RIGHT FACE OF METAL STUD
- ALL DIM. TO EXTERIOR WALLS TAKEN TO INTERIOR FACE OF METAL STUD
- ALL INTERIOR PARTITIONS NOT OTHERWISE NOTED ARE TYPE 'B'
- WALL STUDS SHALL EXTEND UP TO UPPER SIDE OF METAL DECK

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 architecture · planning · interiors
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Scullen & Riva, P.A.
 Structural Engineer
Burdette, Koehler, Murphy & Associates
 Mechanical/Electrical Engineer
Johnson, McCordic & Thompson, P.A.
 Civil Engineer



FIRST FLOOR WEST


DATE: 11/12/60

APPROVED: [Signature]


District Court/ Multi-Service Center

Glen Burnie, Anne Arundel Co., Md.

PROJECT NO. DC 9714
 JOB NO. 75-27
 DATE: 11-12-60
 DRAWING NO. **A-3**

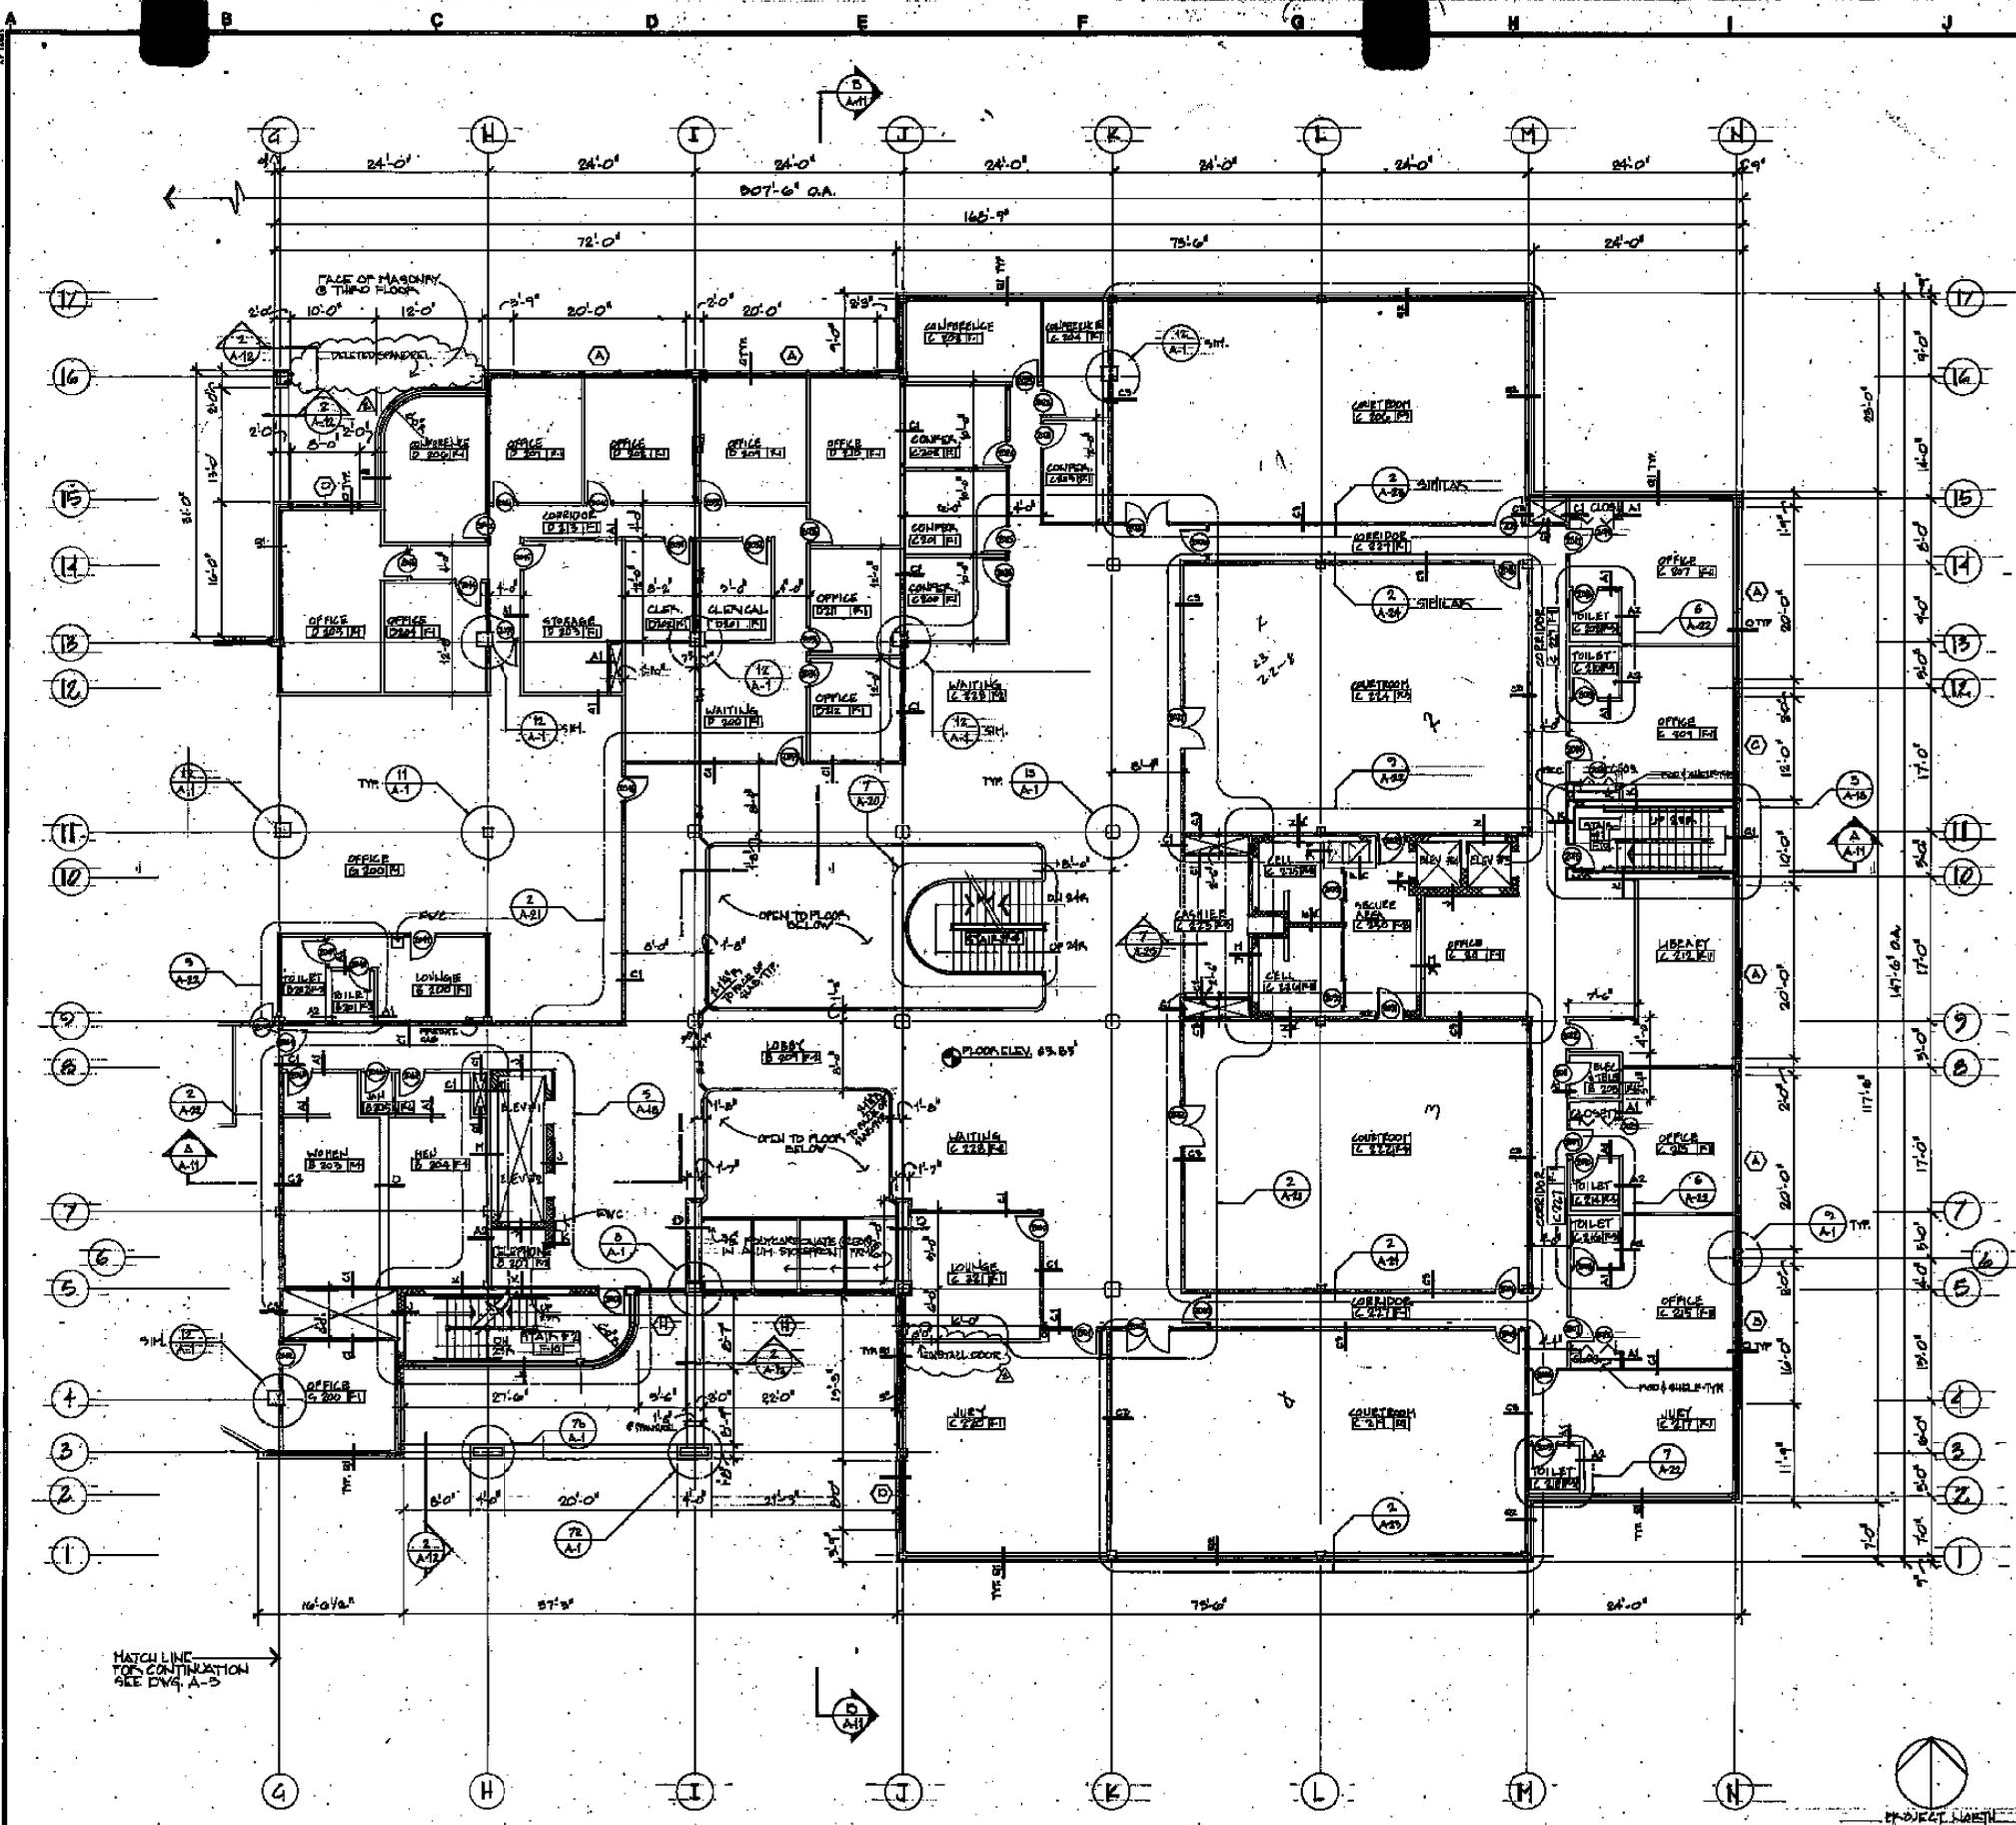

WALL CONSTRUCTION SCHEDULE

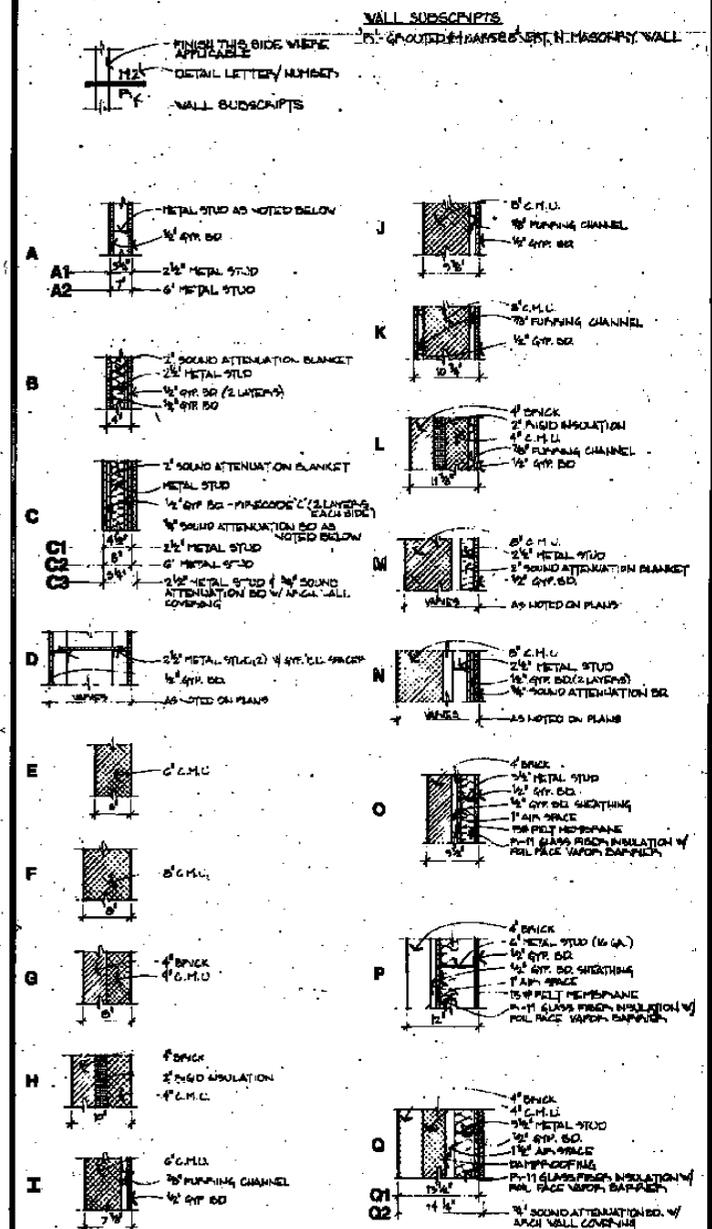

FINISH SCHEDULE

FLOOR NO.	F1	F2	F3	F4	F5	F6	F7	F8	F9	F10	F11	F12
FLOORS	CARPET	C.P.	SSAL MGR	CERAMIC/PORCELAIN MOSAIC	CERAMIC/PORCELAIN MOSAIC	CONC.	CONC. NOTE 5	CONC.	CARPET	V.A.T.	CARPET	
BASES	VINYL	C.P.		CERAMIC/PORCELAIN MOSAIC	VINYL	SPRINT	SPRINT PAINTED	VINYL	VINYL	VINYL		
WALLS	BRICK	V.V.C.	C.P.	C.P.	V.V.C.	PAINT	PAINT	SPRINT PAINTED	NOTE 1	PREPARED BOARD	V.V.C.	
CEILINGS	2-4 S.A.T.	NO. 1 S.A.T.	NOTE 1	P.D. GYP. BO.	P.D. GYP. BO.	2-4 S.A.T.	NOTE 4	SPRINT PAINTED	PAINTED GYP. BO.	SPECIAL ARCH. WALL & PARTITION TREAT.	S.A.T.	S.A.T.
REMARKS												

FINISH NOTES

- SEE 1/4" = 1'-0" PLANS & ELEVATIONS FOR FINISHES
- CERAMIC WALL TILE FULL HEIGHT ON FIXTURE WALL ONLY, VINYL WALL COVERING ON OTHER WALLS - SEE PLAN
- SEE DRAWING A-21 FOR FINISHES
- 2 LAYERS OF 1/2" GYP. BO. OVER 1/2" OF BATT INSULATION ABOVE CEILING & TYP. CLG. PARTITIONS
- TRAFFIC DECK COVERING & PARTITION FLOORS

ABBREVIATIONS: S.A.T. - SUPERACUSTICAL TILE, C.T. - CERAMIC TILE, V.A.T. - VINYL ASBESTOS-TILE, C.P. - CERAMIC PANSERS, V.V.C. - VINYL WALL COVERING


GENERAL NOTES

- ALL VERTICAL DIM. TAKEN TO 1" FROM NATH. FACE OF METAL STUD
- ALL HORIZONTAL DIM. TAKEN TO 1" FROM EAST. FACE OF METAL STUD
- ALL DIM. TO EXTERIOR WALLS TAKEN TO INTERIOR FACE OF METAL STUD
- ALL INTERIOR PARTITIONS NOT OTHERWISE NOTED ARE TYPE "B"
- ALL SHARED WALLS EXTEND UP TO UPPER SIDE OF METAL DECK

PLAN
SCALE: 1/8" = 1'-0"

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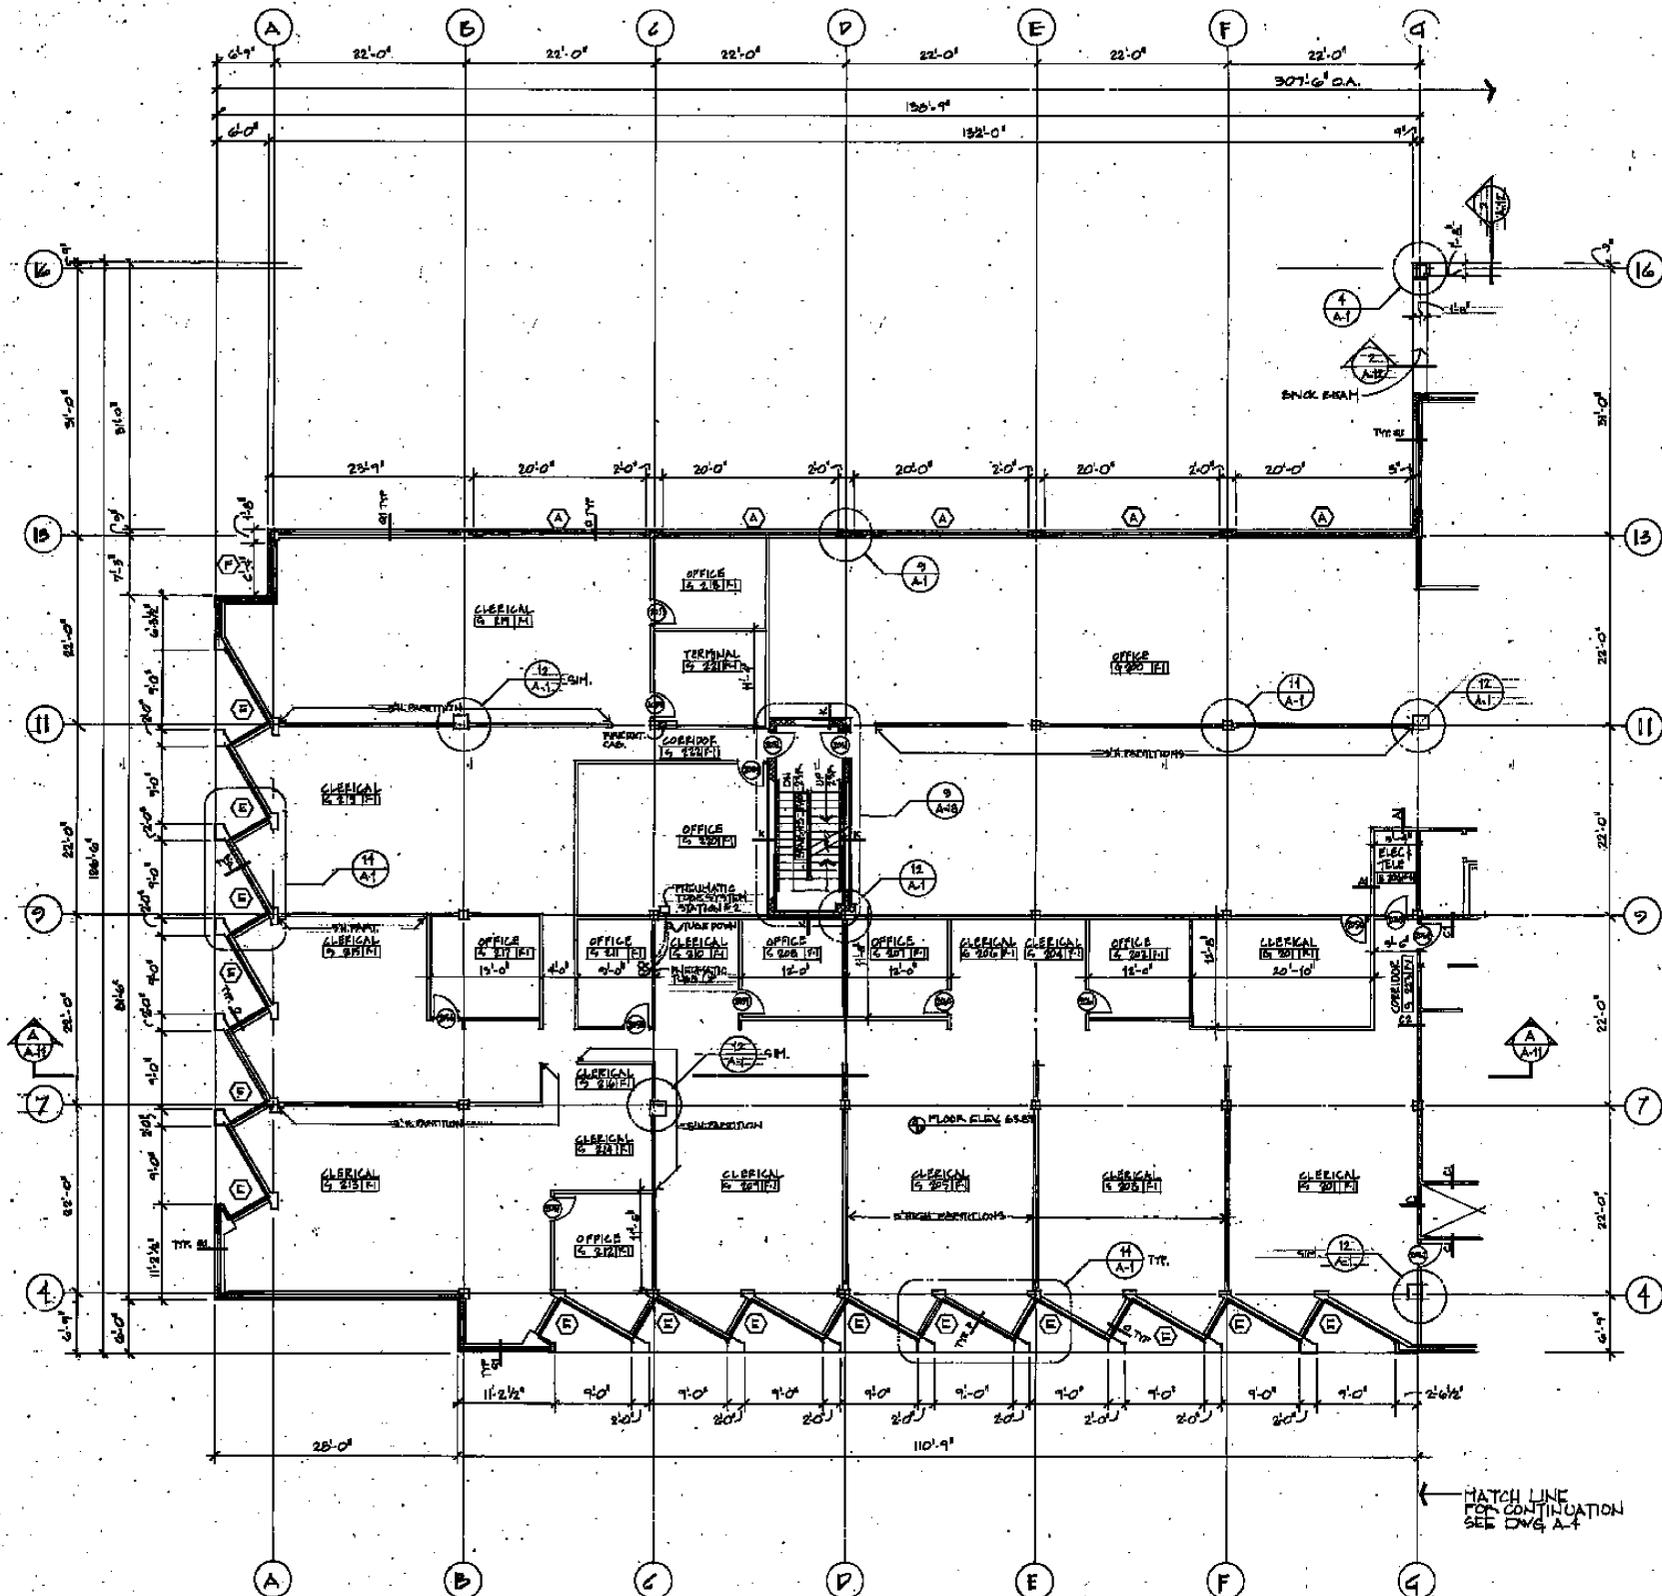
Scullen & Riva, P.A.
 Structural Engineer
Burdette, Koehler, Murphy & Associates
 Mechanical/Electrical Engineer
Johnson, McCordic & Thompson, P.A.
 Civil Engineer

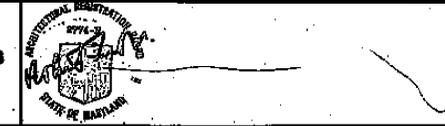


USING AGENCY APPROVAL
 APPROVED
 PROJECT ADMINISTRATOR
 DATE 11/12/80

REVISIONS
 AS BUILT DRAWINGS 7/8/85

**District Court/
 Multi-Service Center**
**Glen Burnie,
 Anne Arundel Co., Md.**
A-4



WALL CONSTRUCTION SCHEDULE

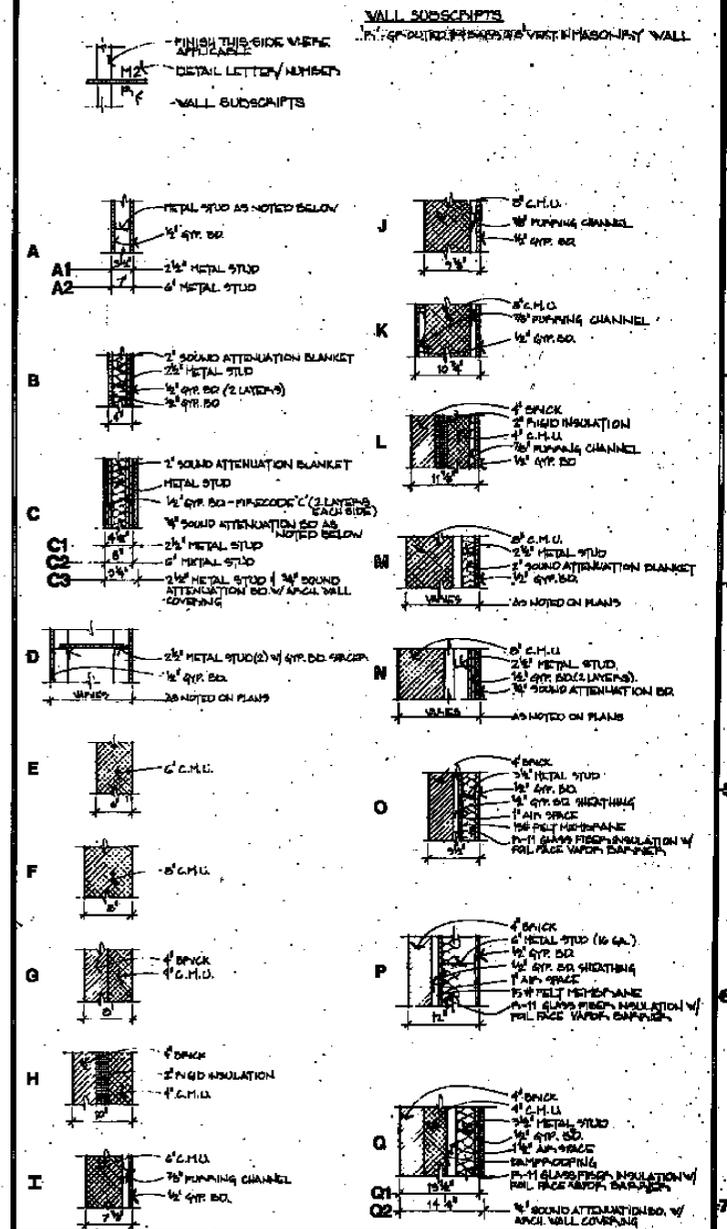

FINISH SCHEDULE

FINISH	F1	F2	F3	F4	F5	F6	F7	F8	F9	F10	F11	F12
FLOORS	CARPET	C.R.	SEALING	CERAMIC MOSAIC	CERAMIC MOSAIC	CONC.	CONC. NOTES	CONC.	CARPET	V.A.T.	CARPET	
BASE	VINYL	C.R.		CERAMIC MOSAIC	CERAMIC MOSAIC	VINYL	PAINT	PAINT	EPoxy PAINTED	VINYL	VINYL	VINYL
WALLS	PAINT	V.V.C.	C.P.	C.P.	V.V.C.	PAINT	PAINT	PAINT	NOTE 1	BRICK	BRICK	V.V.C.
CEILINGS	2x4 S.A.T.	2x4 S.A.T.	NOTE 1	PTD. GYP. BR.	PTD. GYP. BR.	2x4 S.A.T.	NOTE 1	PAINTED CHOCOLATE	PAINTED GYP. BR.	2x4 S.A.T.	2x4 S.A.T.	2x4 S.A.T.
PARTITIONS									SPECIAL ARCH WALL TREAT.			

FINISH NOTES

- SEE 1/4" = 1'-0" PLANS & ELEVATIONS FOR FINISHES
- CERAMIC WALL TILE FULL HEIGHT ON FIXTURE WALL ONLY, VINYL WALL COVERING ON OTHER WALLS - SEE PLAN
- SEE DRAWING A-21 FOR FINISHES
- 2 LAYERS OF 1/2" GYP. BR. OVER 1/2" OF BATT INSULATION ABOVE 2x4 GYP. BR. IN PARTITIONS
- TRAFFIC MARK COVERING IN ENTRY AREAS

ABBREVIATIONS: S.A.T. - SUBP. ACOUSTICAL TILE; C.T. - CERAMIC TILE; V.A.T. - VINYL ARMORED TILE; C.P. - CERAMIC PARTERS; V.V.C. - VINYL WALL COVERING

GENERAL NOTES

- ALL VERTICAL DIM. TAKEN TO 4" FROM UPPER FACE OF METAL STUD
- ALL HORIZONTAL DIM. TAKEN TO 4" FROM RIGHT FACE OF METAL STUD
- ALL DIM. TO EXTERIOR WALLS TAKEN TO INTERIOR FACE OF METAL STUD
- ALL INTERIOR PARTITIONS NOT OTHERWISE NOTED ARE TYPE "D"
- ALL SHARED WALLS EXTEND UP TO UPPER SIDE OF METAL DECK

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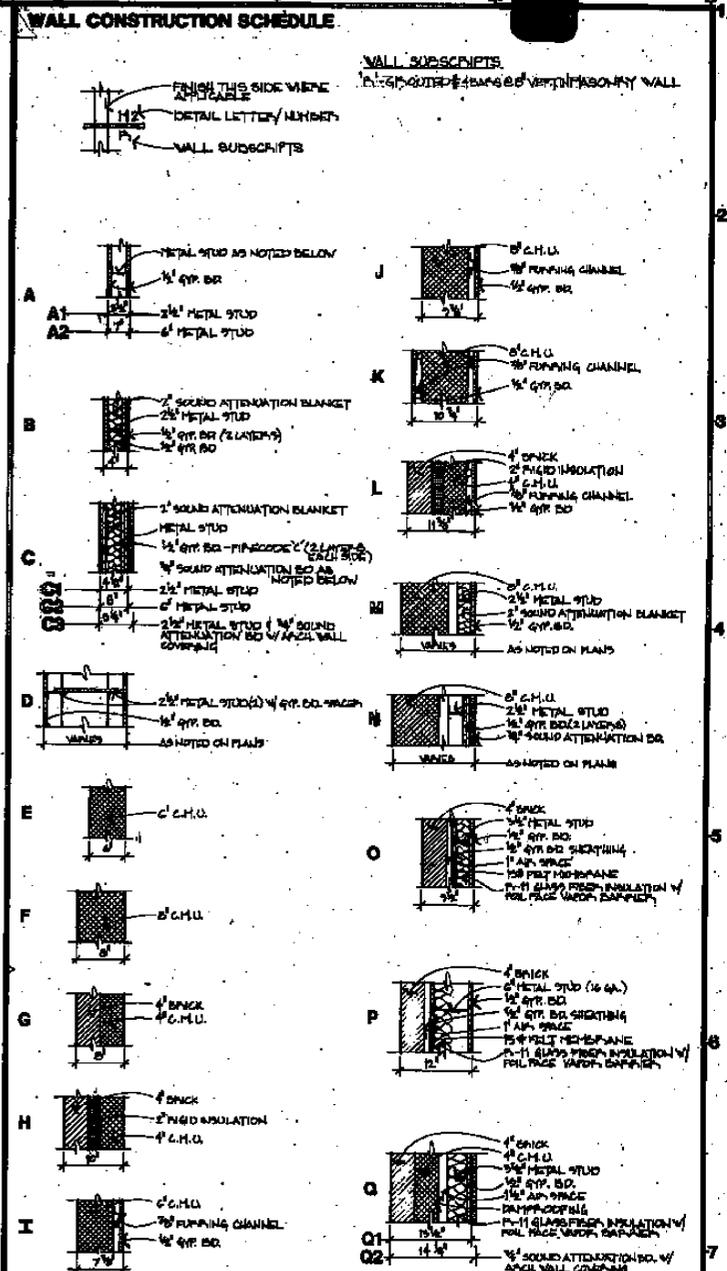
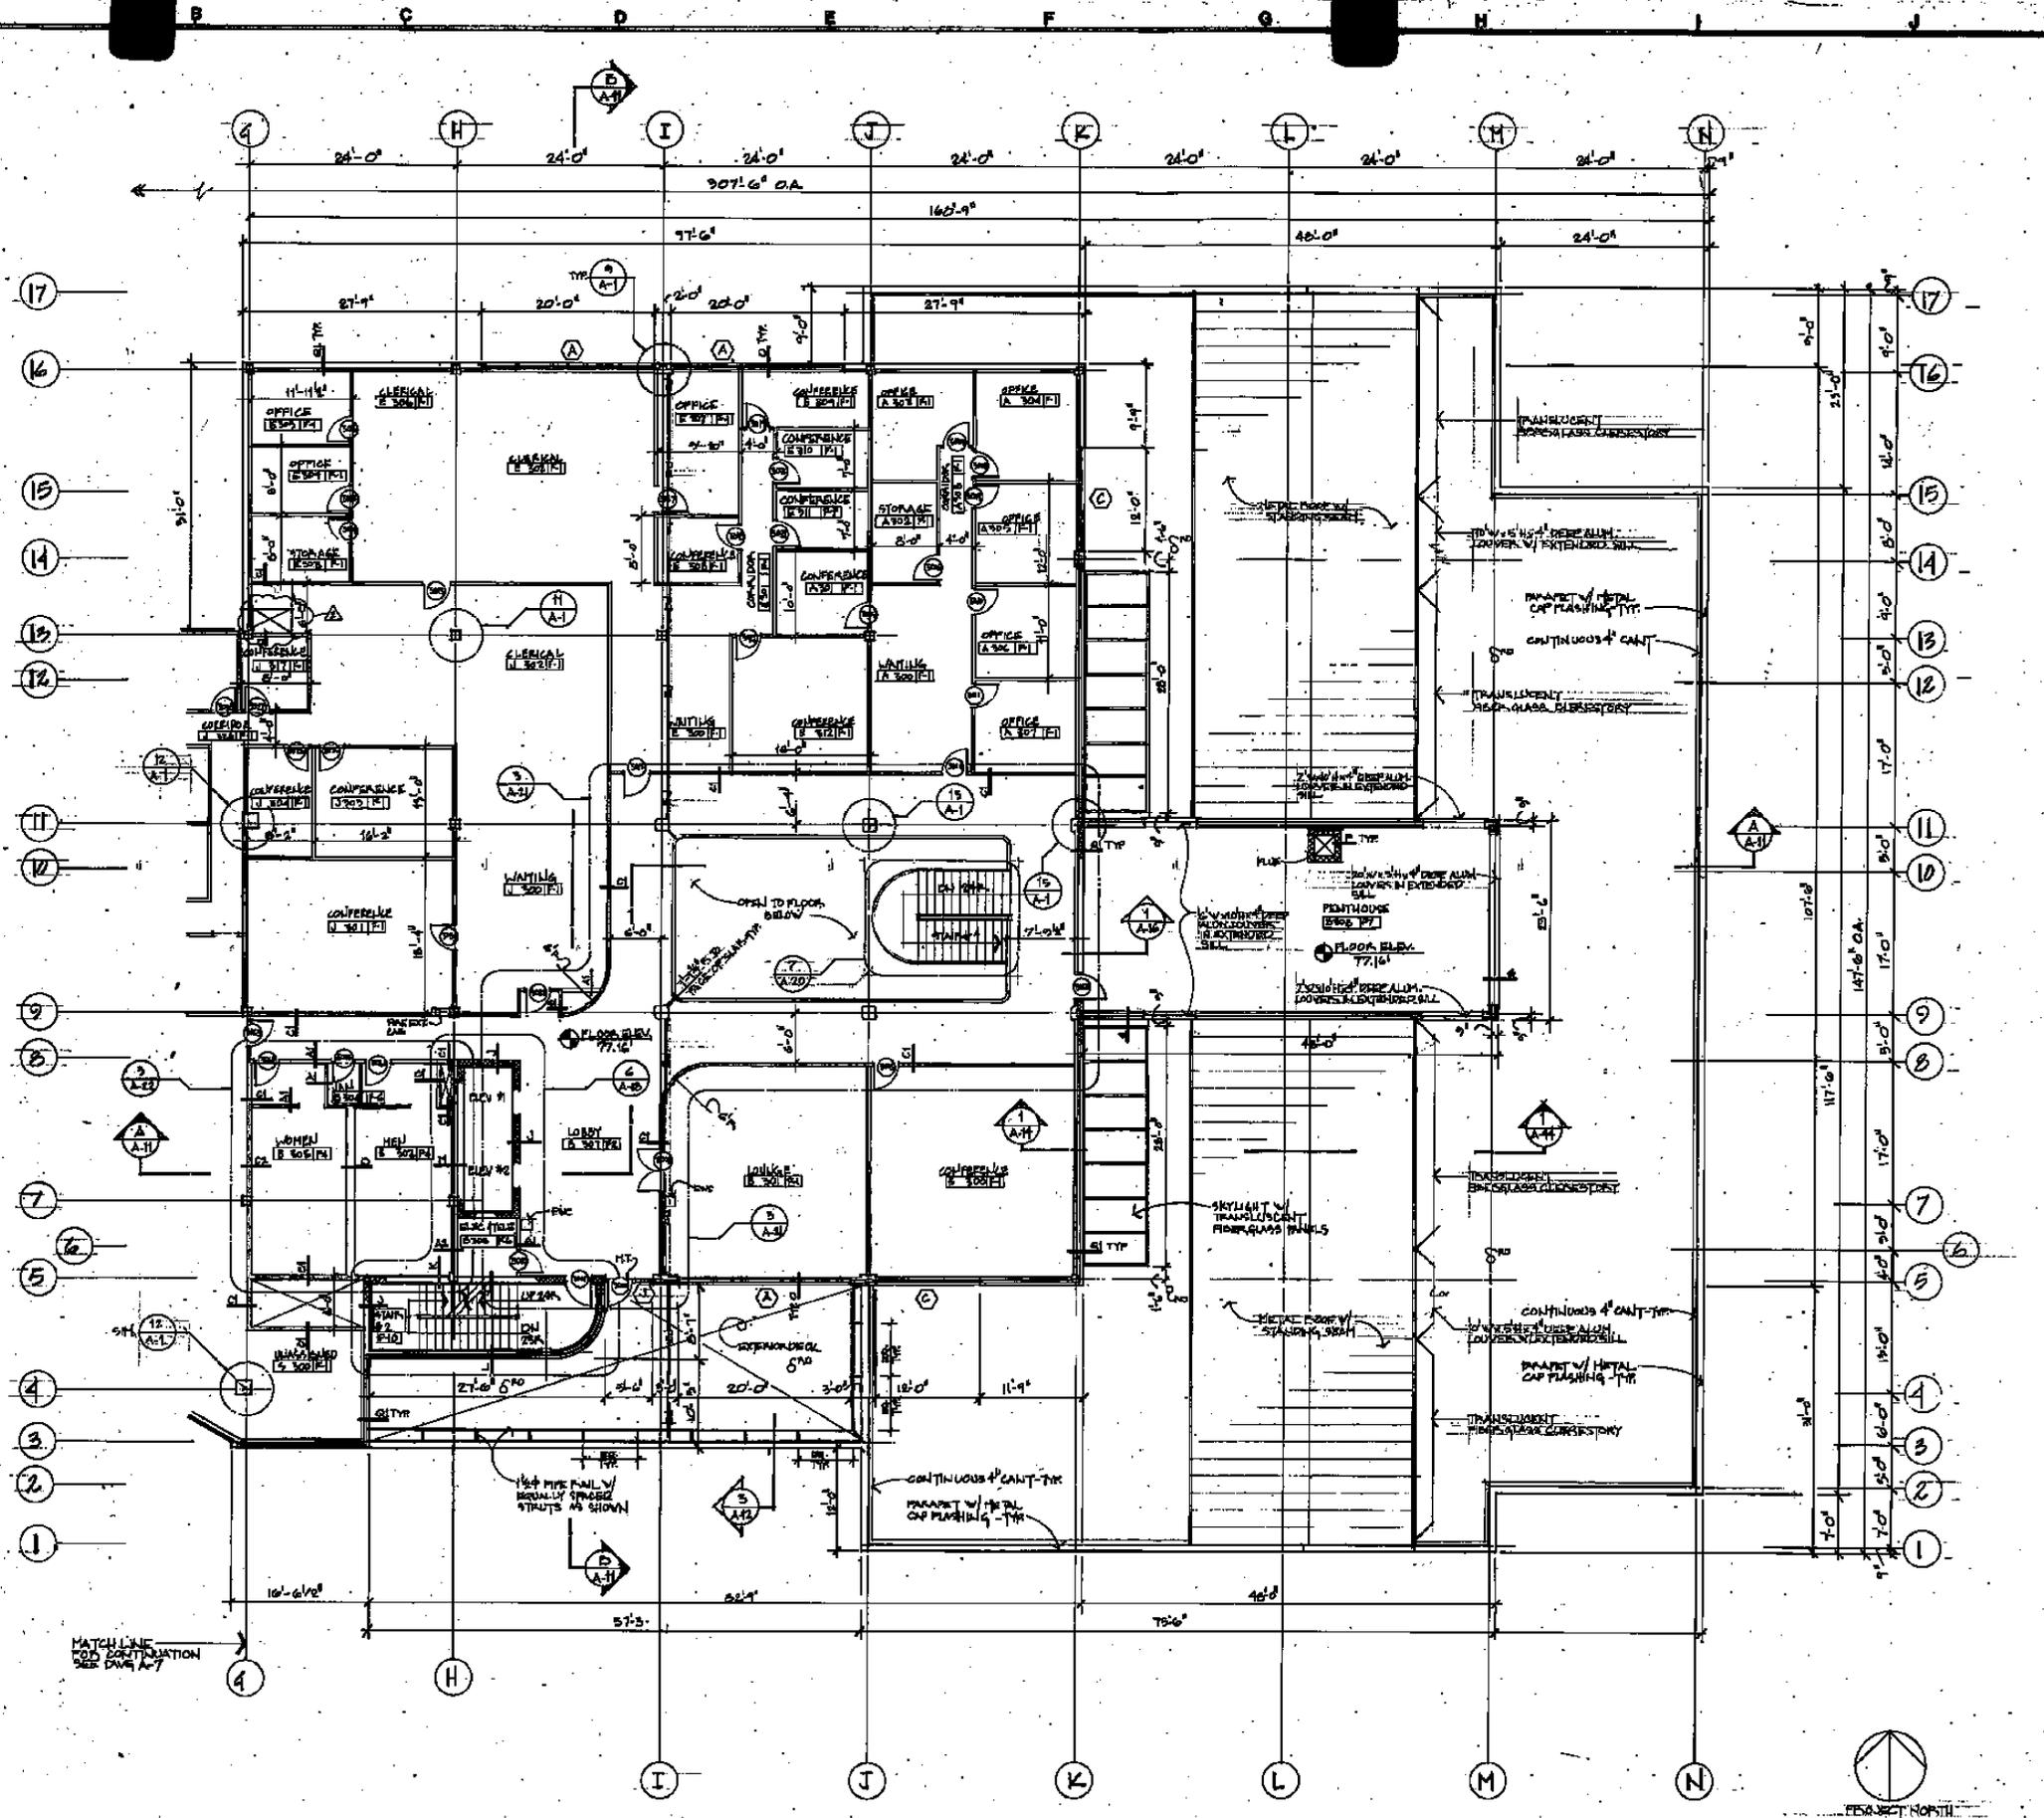
Scullen & Riva, P.A.
 Structural Engineer
Burdette, Koehler, Murphy & Associates
 Mechanical/Electrical Engineer
Johnson, McCordic & Thompson, P.A.
 Civil Engineer

UNIVERSITY OF MARYLAND
 STATE ENGINEER
 JOHN W. KLEIN
 TITLE: _____ DATE: _____

USING AGENCY APPROVAL
 APPROVED: _____
 PROJECT ADMINISTRATOR
 TITLE: _____ DATE: _____

REVISIONS
 1

District Court / Multi-Service Center
Glen Burnie, Anne Arundel Co., Md.
 PROJECT NO. 88-0794
 SHEET NO. 11-2-80
 DRAWING NO. **A-5**



FINISH SCHEDULE

FINISH NO.	F1	F2	F3	F4	F5	F6	F7	F8	F9	F10	F11	F12
FLOORS	CARPET	C.P.	SEAL W/	CERAMIC MOSAIC	CERAMIC MOSAIC	CONC.	CONC.	CONC.	CORNER W.A.T.	CORPET		
BASE	VINYL	C.P.		CERAMIC MOSAIC	CERAMIC MOSAIC	VINYL	PAINT	PAINT	PAINT	VINYL	VINYL	VINYL
WALLS	FINISH	VINYL	C.P.	CERAMIC MOSAIC	CERAMIC MOSAIC	VINYL	PAINT	PAINT	PAINT	PAINT	VINYL	VINYL
CEILINGS	2x4	S.A.T.	NOTES	PTD	PTD	PTD	PTD	PTD	PTD	PTD	PTD	PTD
NOTES												

FINISH NOTES

- SEE 1/4" = 1'-0" PLANS & ELEVATIONS FOR FINISHES
- CERAMIC WALL TILE FULL HEIGHT ON PICTURE WALL ONLY, VINYL WALL COVERING ON OTHER WALLS - SEE PLAN
- SEE DRAWING A-21 FOR FINISHES
- 2 LAYERS OF 1/2" GYP. BR. GUSE W/ 1/2" BATT INSUL. ABOVE ALL PARTS OF ALL EXTERIOR WALLS
- TRAFFIC PROTECTORS ON OPENHOUSE FLOORS

ABBREVIATIONS: S.A.T. - SUSP. ACoustical TILE; C.T. - CERAMIC TILE; V.A.T. - VINYL ASBESTOS TILE
 C.P. - CERAMIC PAVERS; V.W.C. - VINYL WALL COVERING

GENERAL NOTES

- ALL VERTICAL DIM. TAKEN TO FACE OF METAL STUD
- ALL HORIZONTAL DIM. TAKEN TO FACE OF METAL STUD
- ALL DIM. TO EXTERIOR WALLS TAKEN TO INTERIOR FACE OF METAL STUD
- ALL INTERIOR PARTITIONS NOT OTHERWISE NOTED ARE TYPE - D
- ALL SHADDED WALLS EXTEND UP TO UNDER SIDE OF METAL DECK

PLAN
 SCALE 1/8" = 1'-0"

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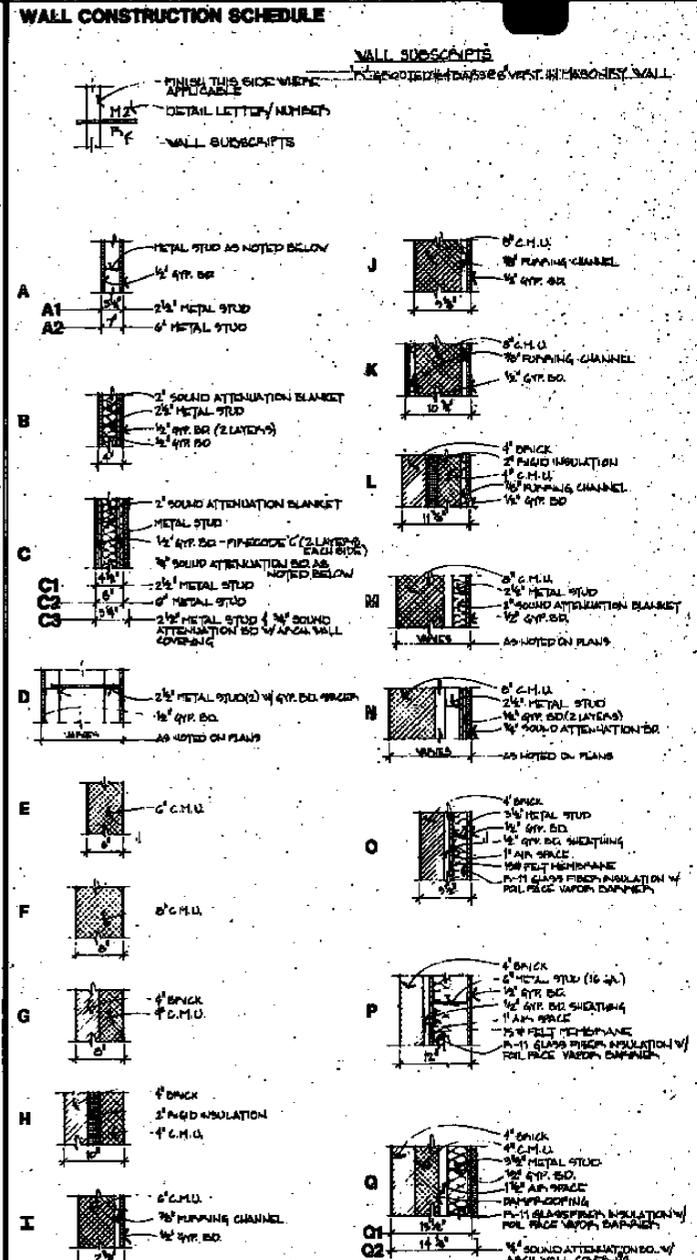
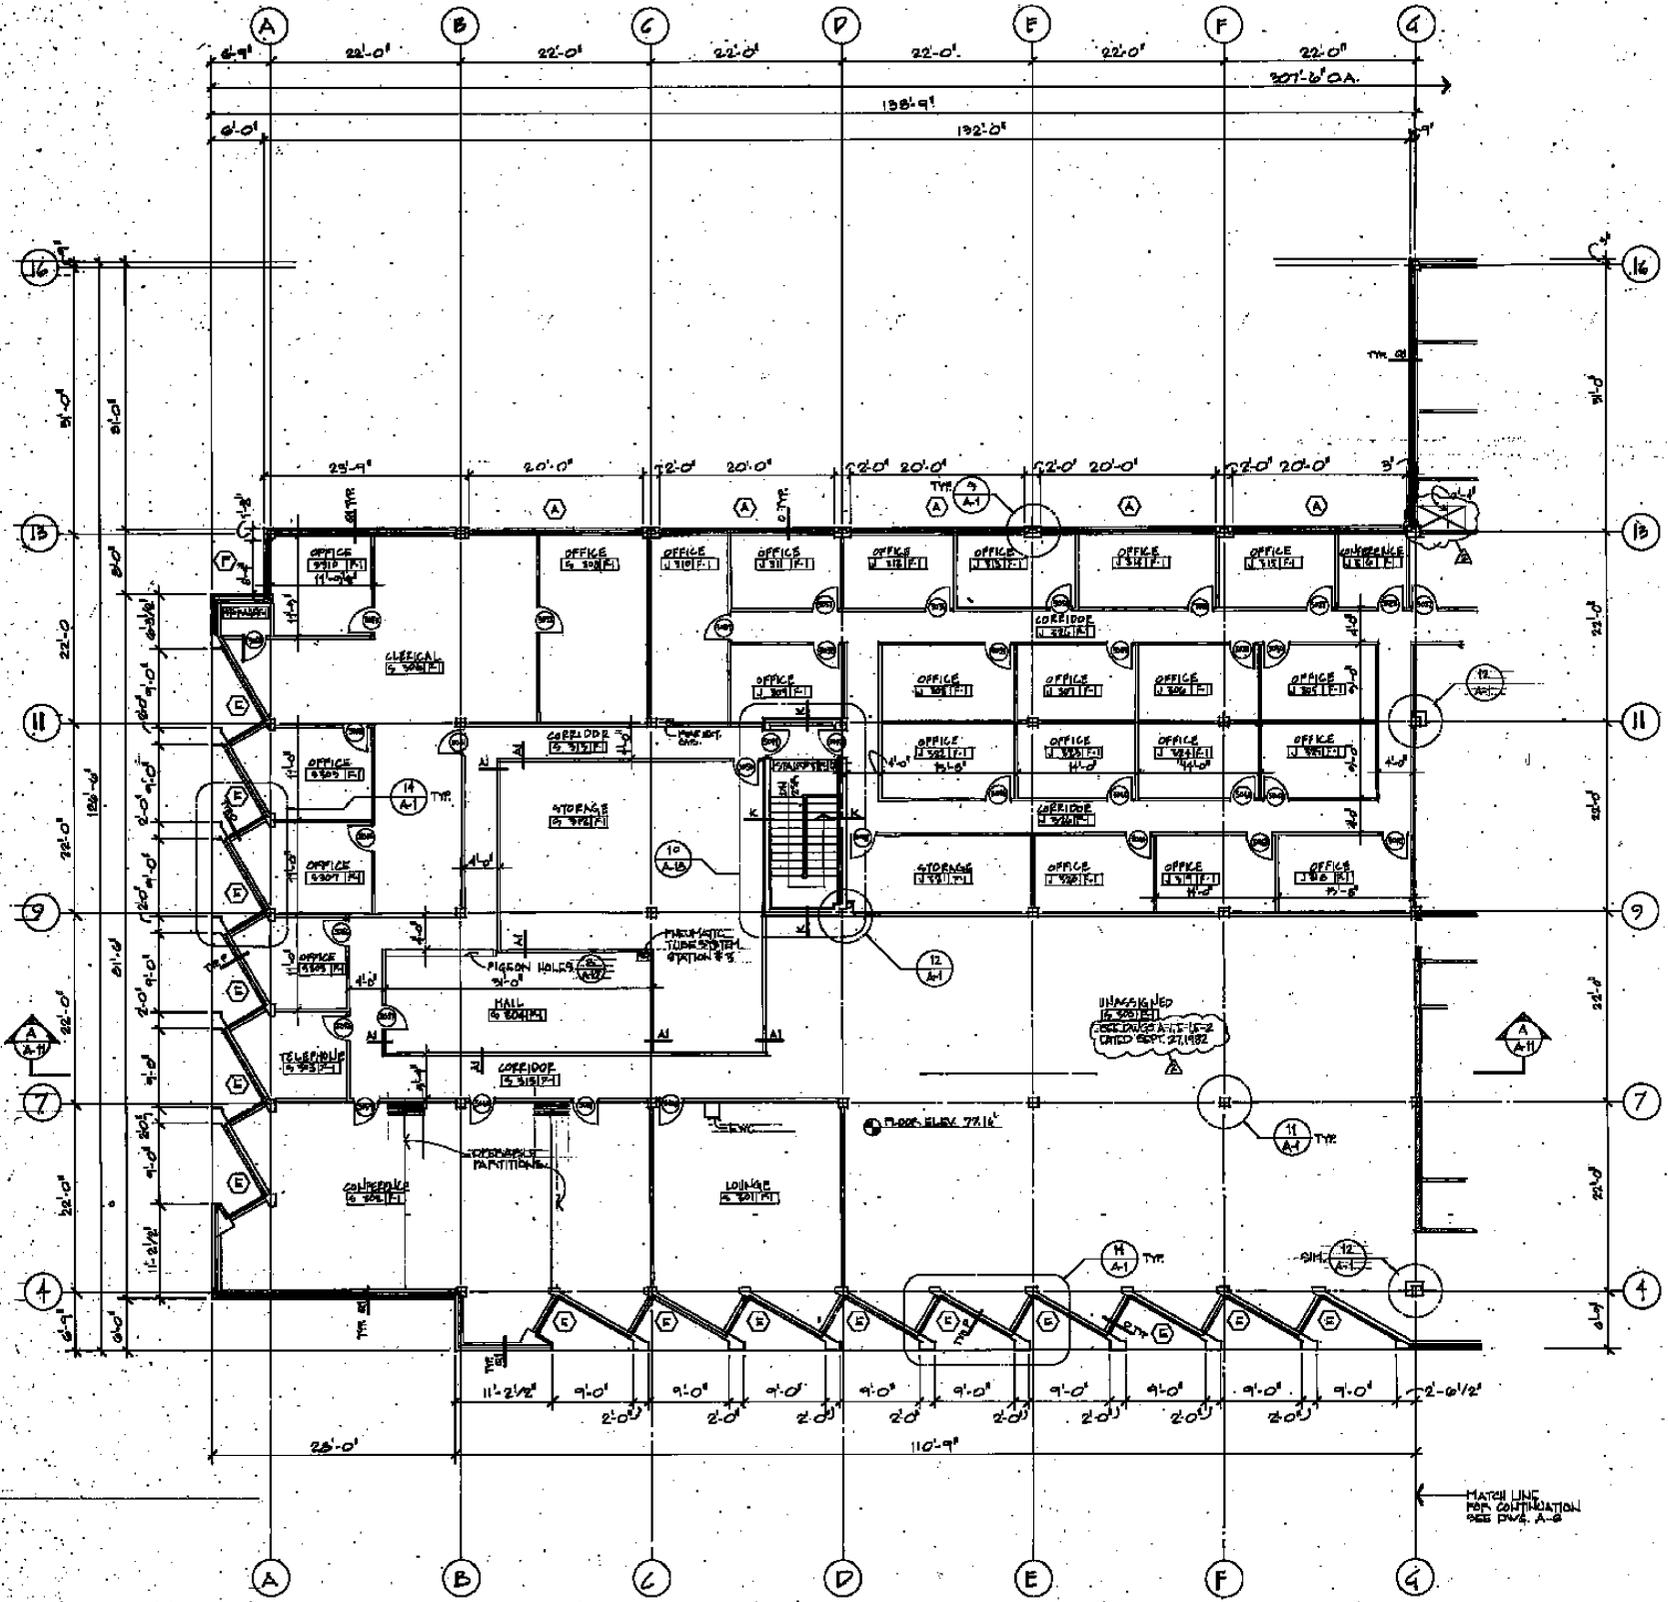
Scullen & Riva, P.A.
 Structural Engineer
Burdette, Koeltner, Murphy & Associates
 Mechanical/Electrical Engineer
Johnson, McCordic & Thompson, P.A.
 Civil Engineer

APPROVED
[Signature]
 PROJECT ADMINISTRATOR
 DATE 11/12/80

APPROVED
[Signature]
 PROJECT ADMINISTRATOR
 DATE 11/12/80

REVISIONS
 Δ AS BUILT DRAWINGS 11/85

**District Court/
 Multi-Service Center**
**Glen Burnie,
 Anne Arundel Co., Md.**
A-6



FINISH SCHEDULE

FINISH NO.	F1	F2	F3	F4	F5	F6	F7	F8	F9	F10	F11	F12
FLOORS	CARPET	C.P.	SAL. MAR.	CERAMIC MOSAIC	CERAMIC MOSAIC	CONC.	CONC. W/TS	CONC.	CARPET	CARPET	CARPET	CARPET
BASE	VINYL	C.P.	CERAMIC MOSAIC	CERAMIC MOSAIC	VINYL	5" PAINT	5" EPoxy PAINTED	VINYL	VINYL	VINYL	VINYL	VINYL
WALLS	5" GYP. BOARD	WALL COVERING	C.P.	5" GYP. BOARD	VWVC	PAINT	PAINT	NOTE 1	NOTE 1	NOTE 1	NOTE 1	NOTE 1
CEILING	2 1/2" S.A.T.	10" GYP. BOARD	NOTE 1	PTD. GYP. BD.	PTD. GYP. BD.	2 1/2" S.A.T.	NOTE 4	NOTE 4	PAINTED GYP. BD.	PAINTED GYP. BD.	2 1/2" S.A.T.	2 1/2" S.A.T.
PARTITIONS									SPECIAL FINISH	SPECIAL FINISH	SPECIAL FINISH	SPECIAL FINISH

FINISH NOTES

- SEE 1/4"=1'-0" PLANS & ELEVATIONS FOR FINISHES
- CERAMIC WALL TILE FULL HEIGHT ON PICTURE WALL ONLY, VINYL WALL COVERING ON OTHER WALLS - SEE PLAN
- SEE DRAWING A-21 FOR FINISHES
- 2 1/2" GYP. BOARD SUPPORTS 5" PARTITION WALLS - SEE PLAN FOR PARTITION TYPES
- TRAFFIC DECK COVERING & PARTITION DECK SURF.

ABBREVIATIONS: S.A.T. - SLIP RESISTANT TILE; C.T. - CERAMIC TILE; V.A.T. - VINYL ASBESTOS TILE; C.P. - CERAMIC PAVEMENT; VWVC - VINYL WALL COVERING

GENERAL NOTES

- ALL VERTICAL DIM. TAKEN TO TOP OF METAL STUD
- ALL HORIZONTAL DIM. TAKEN TO FACE OF METAL STUD
- ALL DIM. TO EXTERIOR WALLS TAKEN TO INTERIOR FACE OF METAL STUD
- ALL INTERIOR PARTITIONS NOT OTHERWISE NOTED ARE TYPE "B"
- ALL STAGED WALLS EXTEND UP TO COVER TOP OF METAL STUD

PLAN
SCALE 1/4"=1'-0"

THIRD FLOOR WEST

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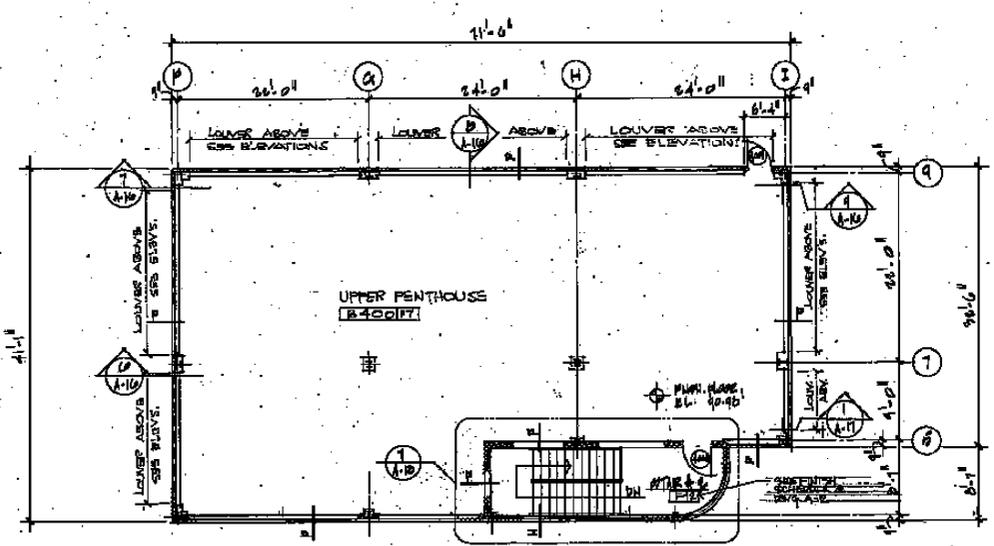
Scullen & Riva, P.A.
 Structural Engineer
Burdette, Koehler, Murphy & Associates
 Mechanical/Electrical Engineer
Johnson, McCordic & Thompeon, P.A.
 Civil Engineer

USING AGENCY APPROVAL
 APPROVED
 PROJECT ADMINISTRATOR
 DATE


REVISIONS
 1. AS BUILT DRAWING 6/6/85

District Court/
 Multi-Service Center
 Glen Burnie,
 Anne Arundel Co., Md.

PROJECT NO. 80 754
 JOB NO.
 DATE 11-12-80
 DRAWING NO.
A-7



UPPER PENTHOUSE FLOOR PLAN
1/16" = 1'-0"

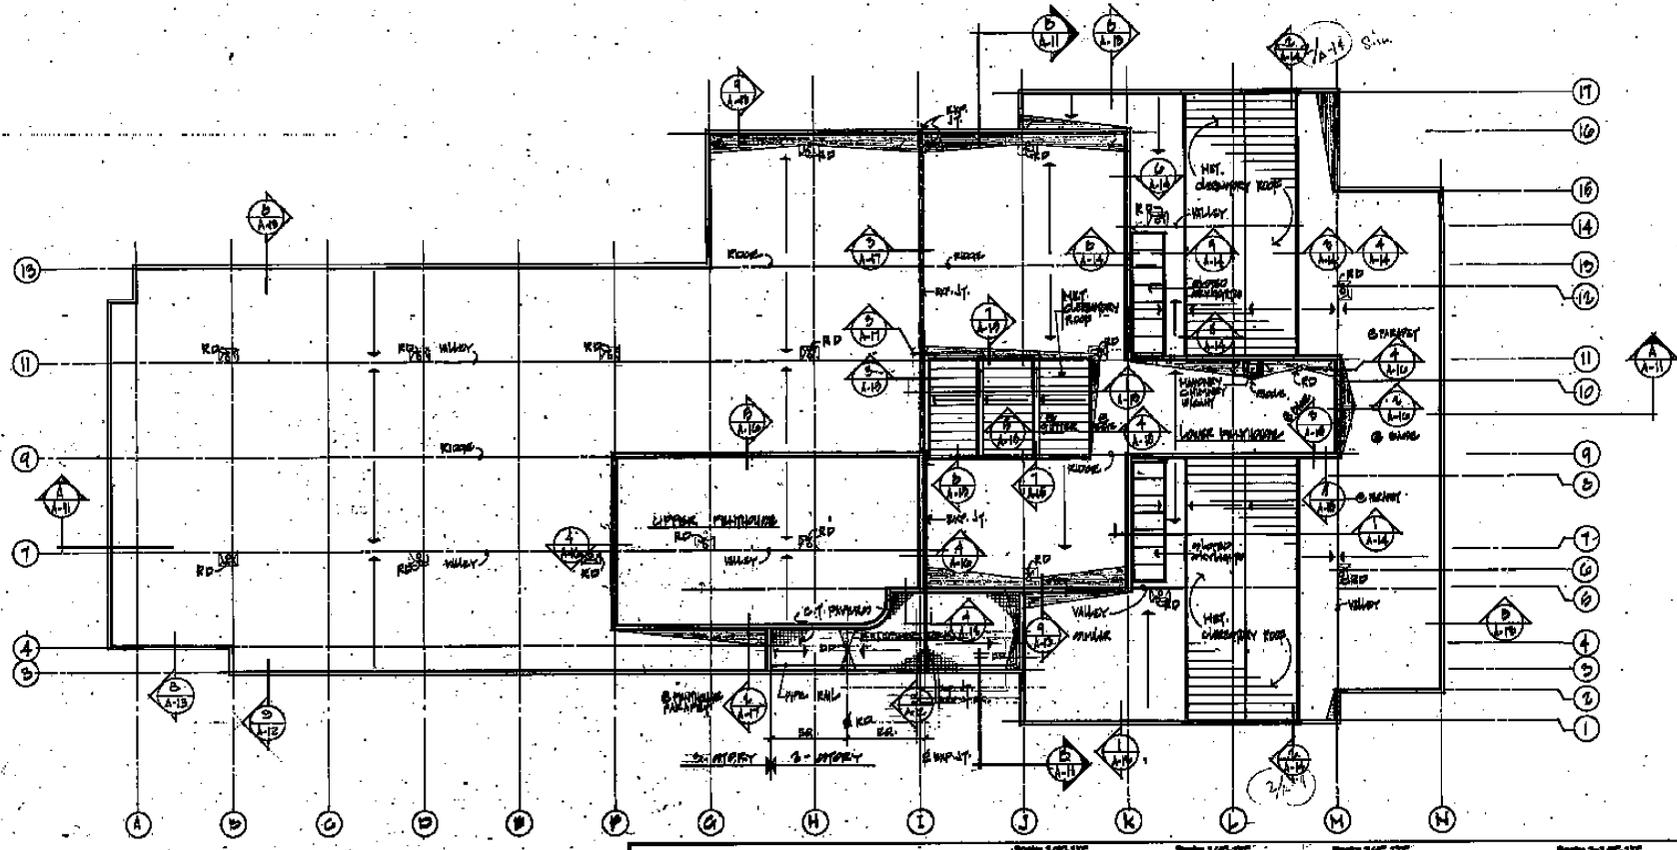

LEGEND

- ① RAMP IN/OUT, TAPERED EDGE STAIR
- ② SLOPED CONC. FILL w/ CERAMIC TILES OR EXTERIOR DECK
- DIRECTION OF ROOF SLOPE
- RD ROOF DRAIN (SEE TYPICAL DRAWING)
- DD DRAIN DRAIN (SEE TYPICAL DRAWING)



ROOF PLAN
1/16" = 1'-0"

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Scullen & Riva, P.A.
Structural Engineer
Burdette, Koehler, Murphy & Associates
Mechanical/Electrical Engineer
Johnson, McCordic & Thompson, P.A.
Civil Engineer





USING AGENCY APPROVAL
[Signature]
DATE

APPROVED
[Signature]
PROJECT ADMINISTRATOR
DATE

REVISIONS

District Court/
Multi-Service Center
Glen Burnie,
Anne Arundel Co., Md.

PROJECT NO. DC 7818
JOB NO. 78-03
DATE 11/16/80
DRAWING NO. **A-8**

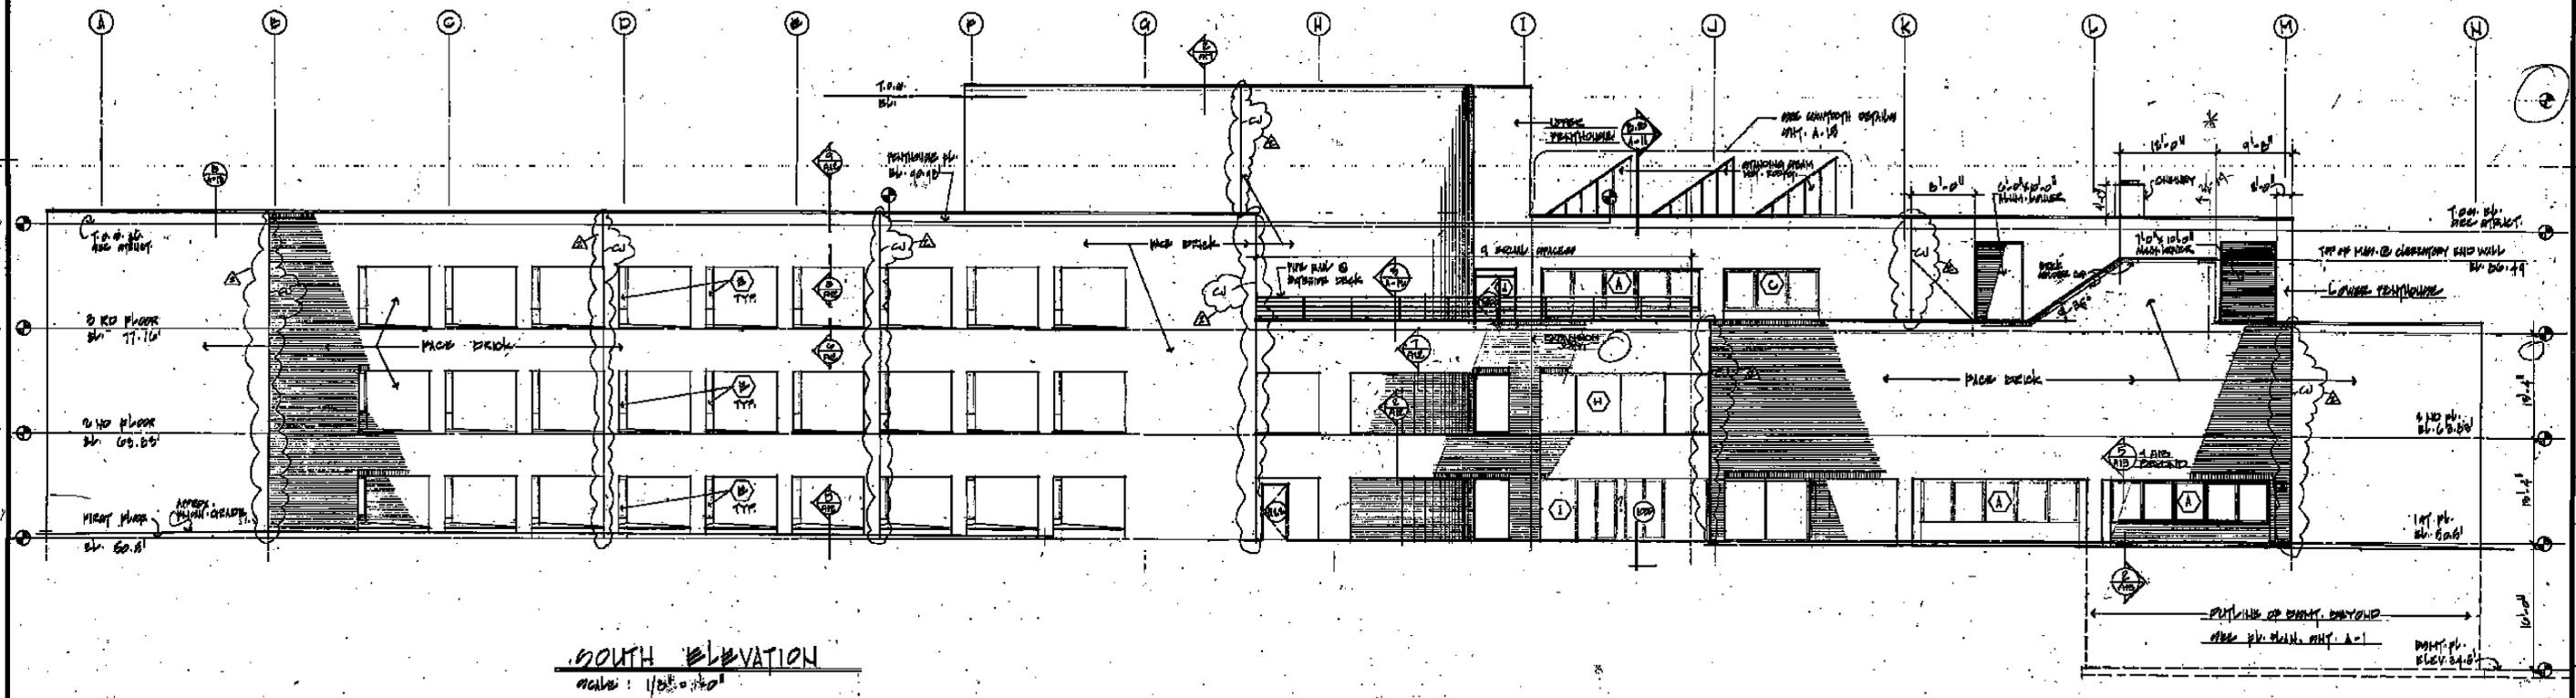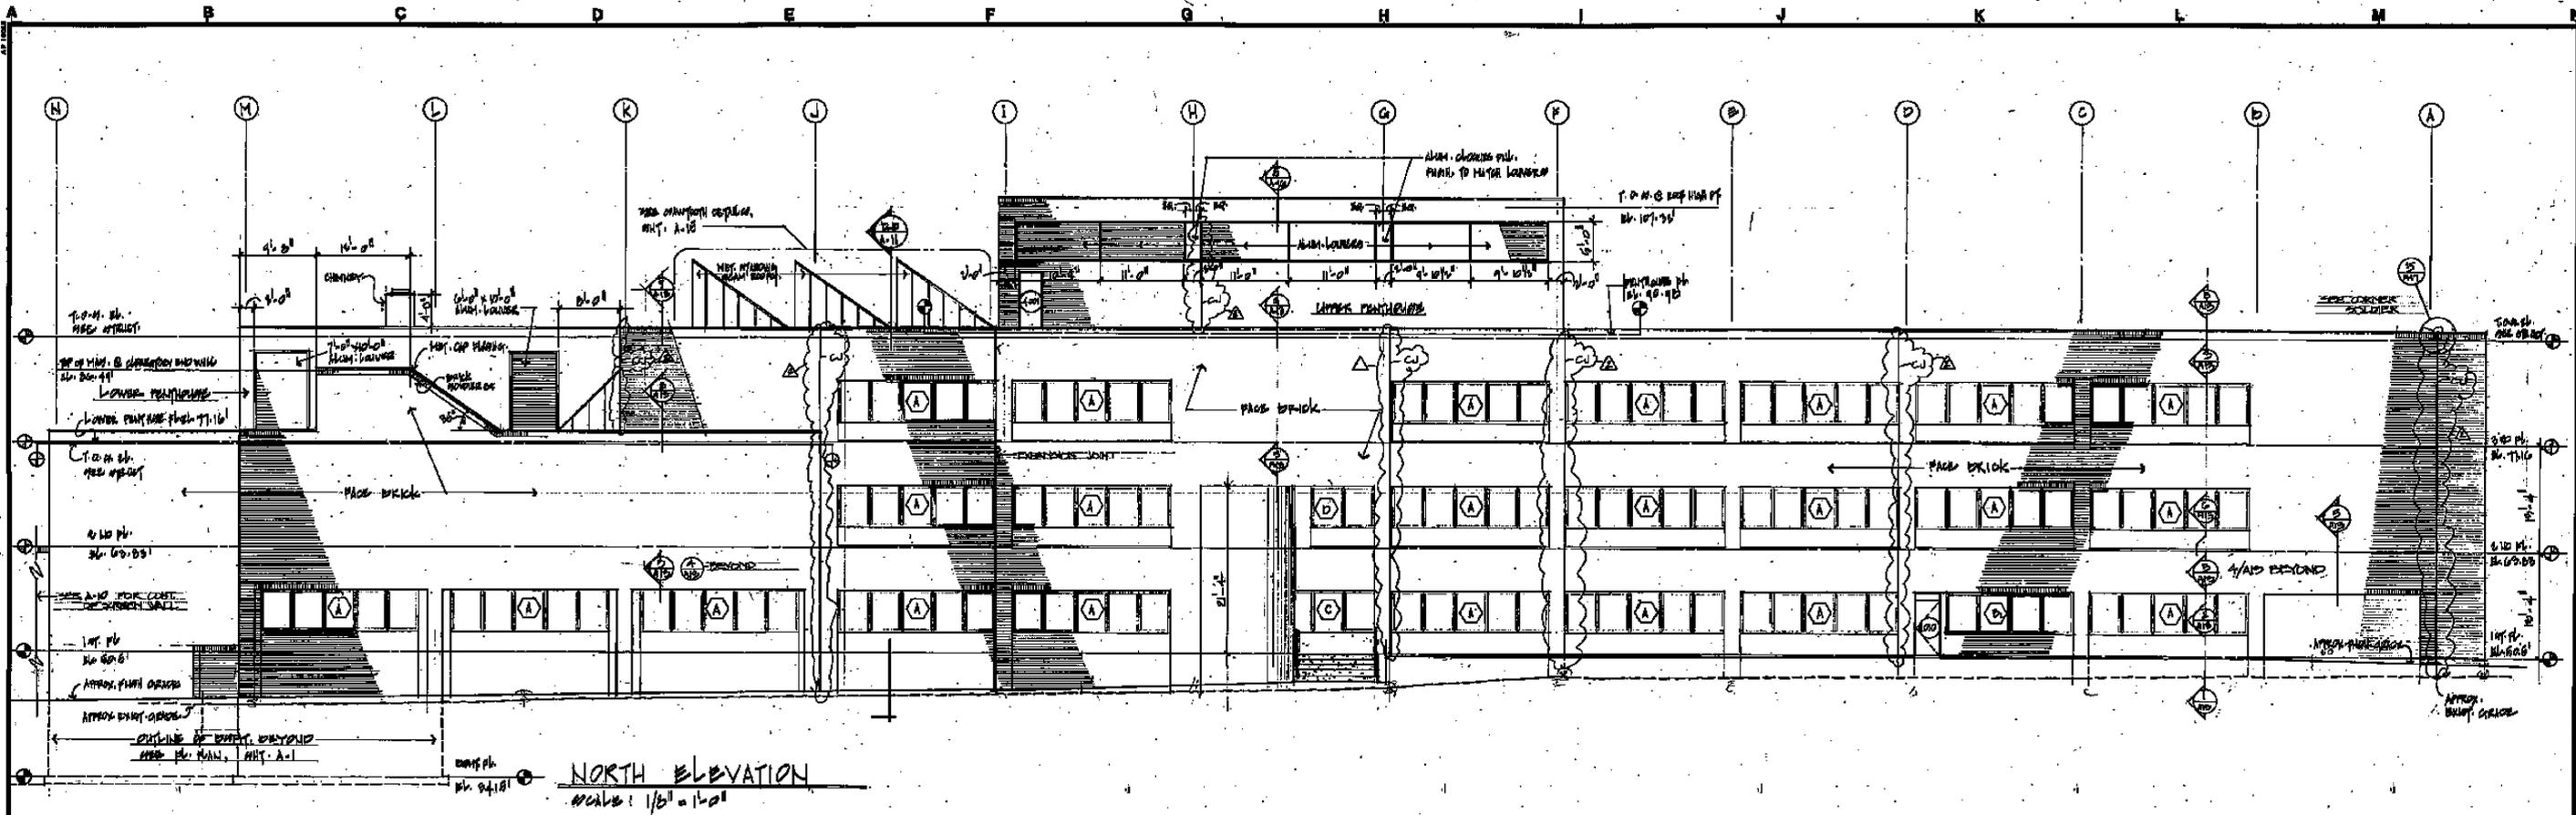

ELEVATIONS

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Scullen & Riva, P.A.
 Structural Engineer
Burdette, Koehler, Murphy & Associates
 Mechanical/Electrical Engineer
Johnson, McCordic & Thompson, P.A.
 Civil Engineer




USING AGENCY APPROVAL
[Signature]
 DATE 11/26/05

APPROVED
[Signature]
 PROJECT ADMINISTRATOR
 DATE 11/26/05


REVISIONS
 AS BUILT DRAWINGS 7/1/05

**District Court/
 Multi-Service Center**
**Glen Burnie,
 Anne Arundel Co., Md.**


PROJECT NO. DC 7614
 SHEET NO. 18 OF 20
 DATE 11/26/05
 DRAWING NO. **A-9**

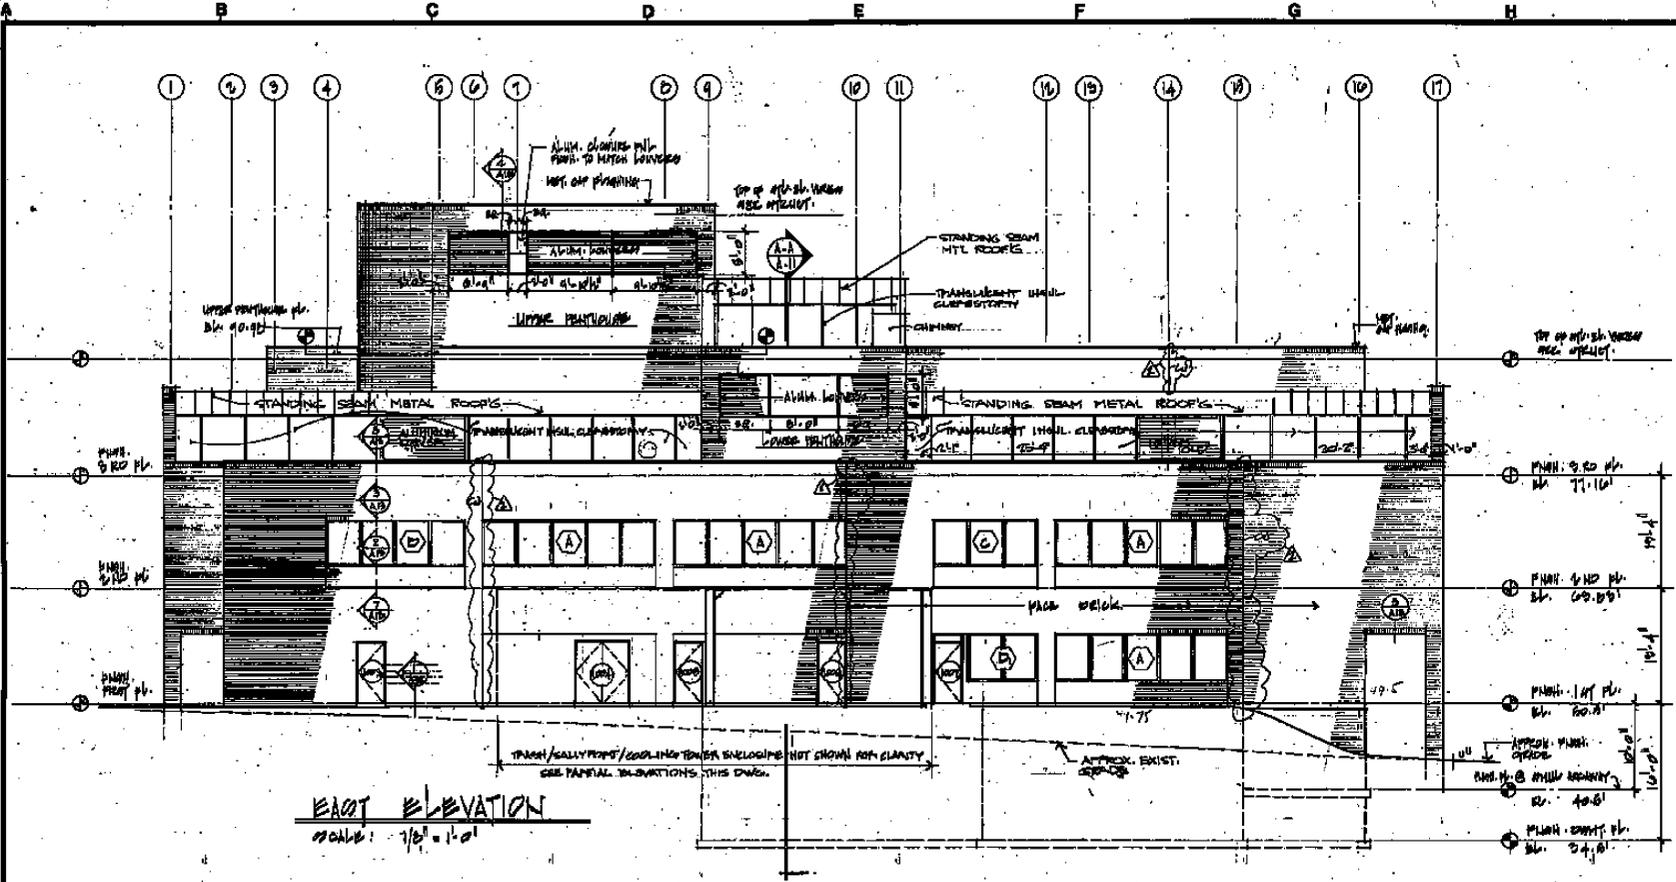


EAST ELEVATION
SCALE: 1/8" = 1'-0"

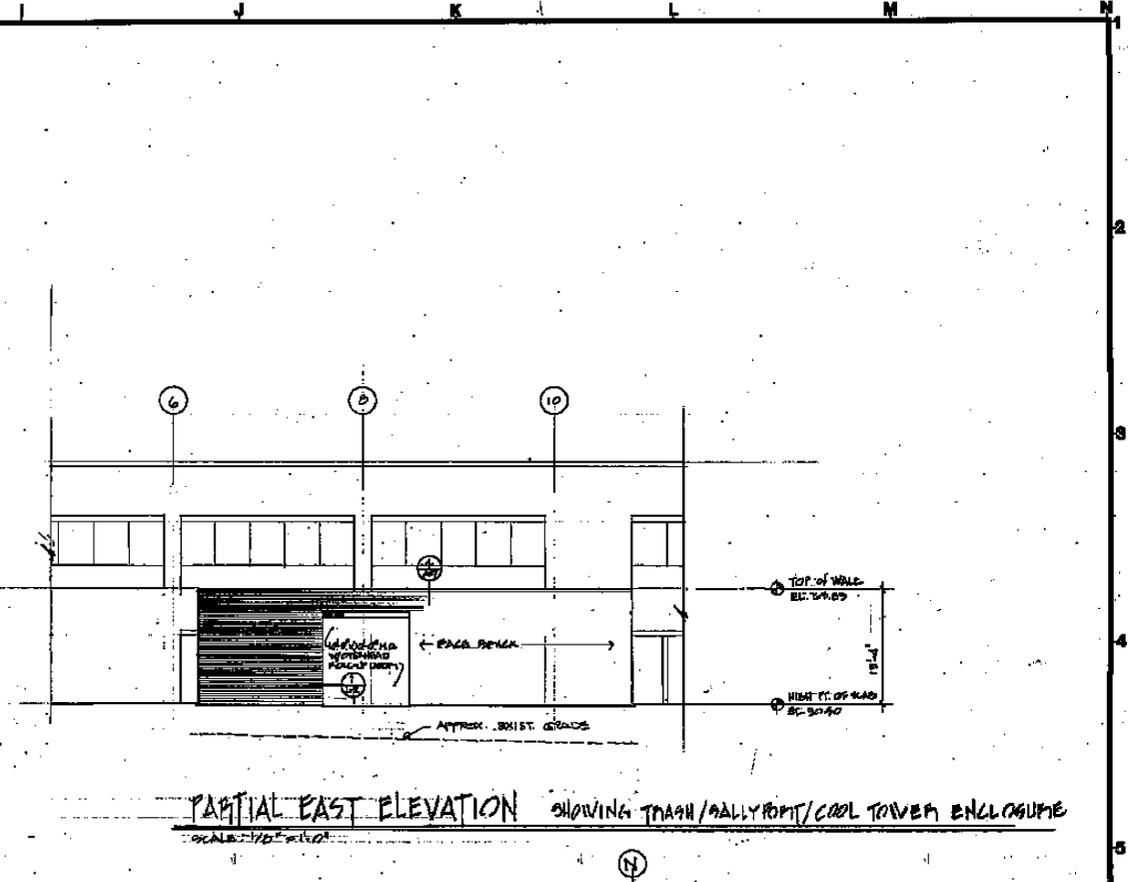

PARTIAL EAST ELEVATION SHOWING TRASH/RALLYPORT/COOL TOWER ENVELOPES
SCALE: 1/8" = 1'-0"

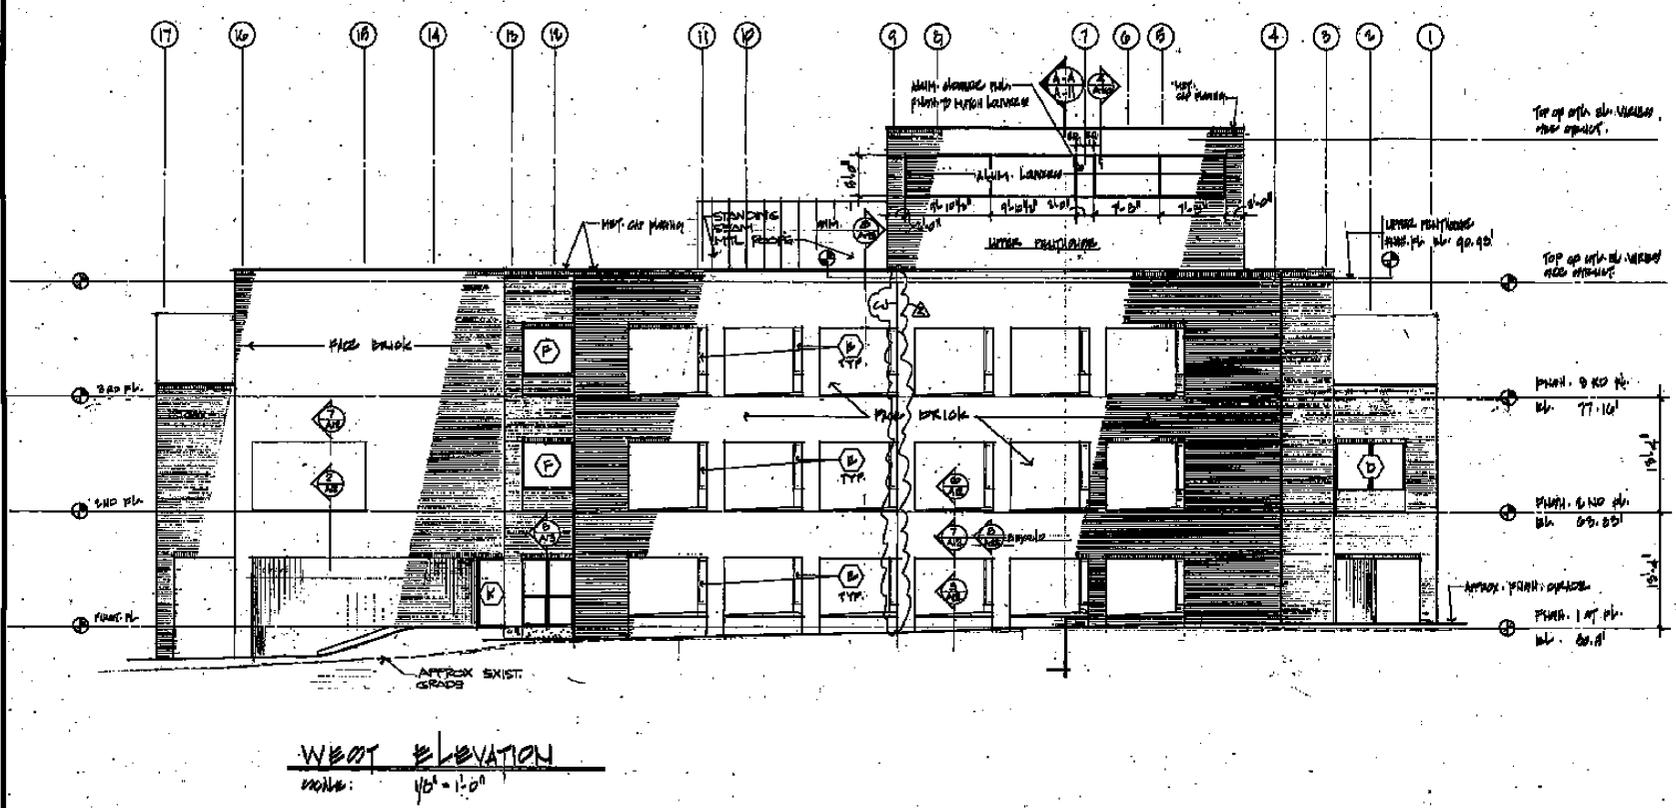


WEST ELEVATION
SCALE: 1/8" = 1'-0"

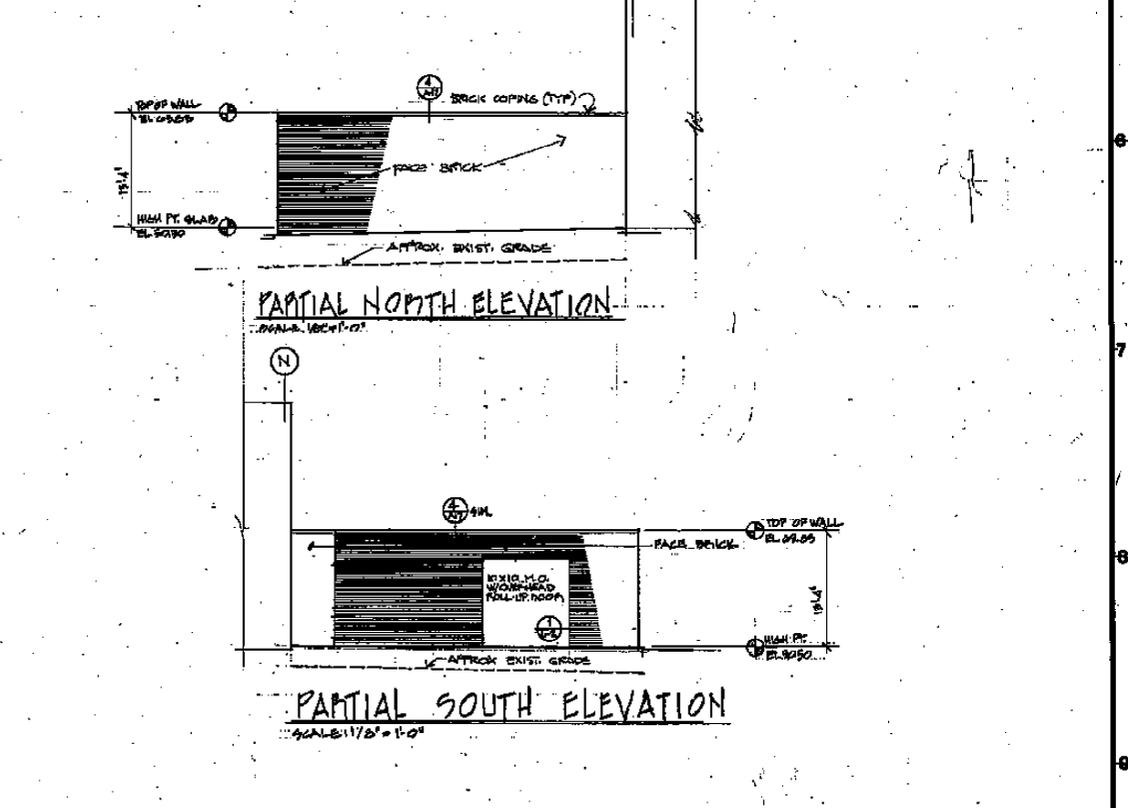


PARTIAL NORTH ELEVATION
SCALE: 1/8" = 1'-0"

PARTIAL SOUTH ELEVATION
SCALE: 1/8" = 1'-0"

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			ELEVATIONS				

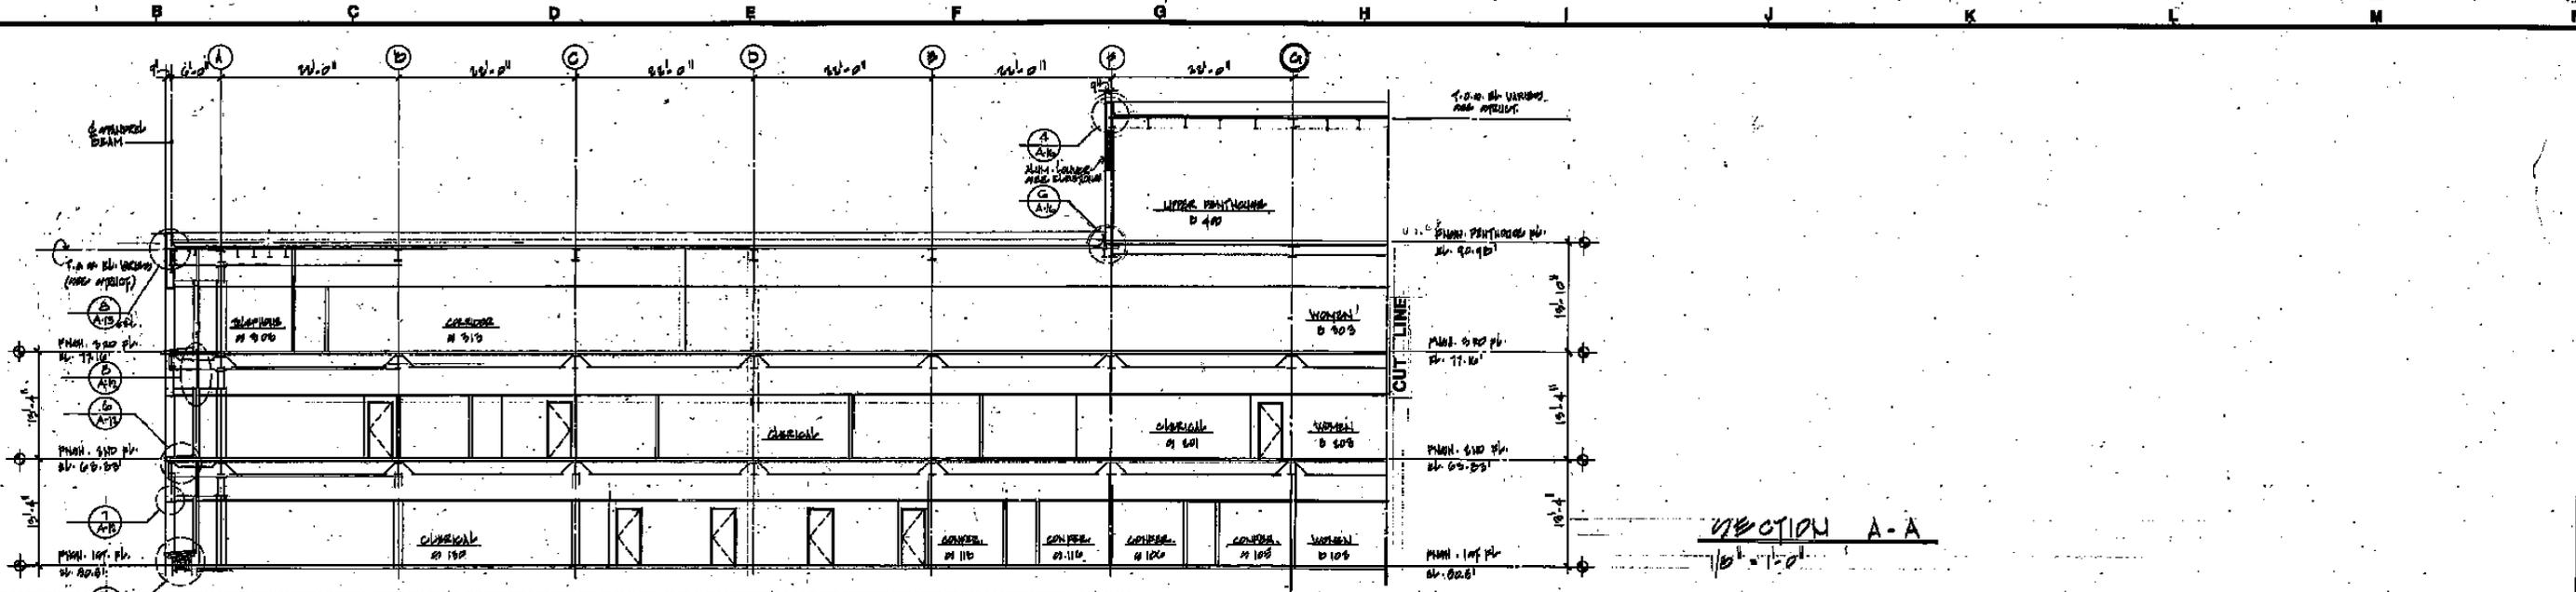

SECTION A-A
1/8" = 1'-0"

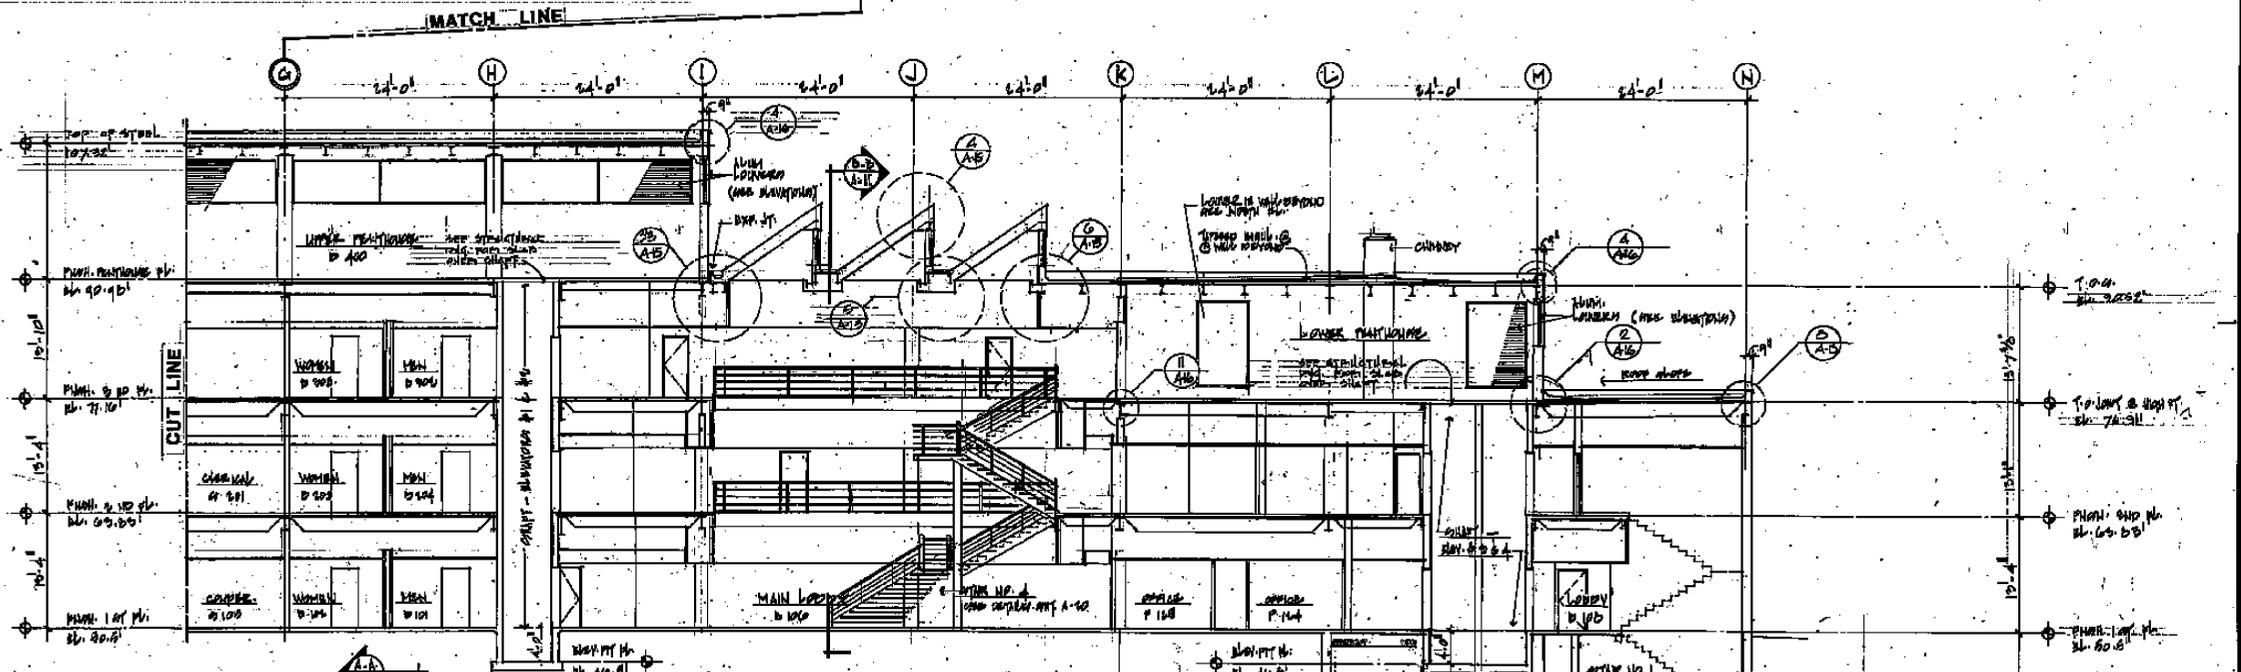

SECTION A-A
1/8" = 1'-0"

SECTION B-B
1/8" = 1'-0"

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Scullen & Riva, P.A.
Structural Engineer
Burdette, Koehler, Murphy & Associates
Mechanical/Electrical Engineer
Johnson, McCordic & Thompson, P.A.
Civil Engineer



USING AGENCY APPROVAL
APPROVED
DATE
TITLE

BUILDING SECTIONS

REVISIONS
DATE

District Court/
Multi-Service Center
Glen Burnie,
Anne Arundel Co., Md.

PROJECT NO. 207814
JOB NO. 11150
DRAWING NO. **A-11**

SCHLAGE

Model: SRCNX-R
Access Control Network Reader Controller
Schlage Reference Material:
Form SSMSH10/16/09 Rev. 2-5.3.5 SP1
Input: 24VDC
Output: 24VDC

Maximum Current Draw: 360mA Max.



LISTED

General Signaling
Equipment
52AB




LISTED

Equipment,
Access Control
52AB

SCHLAGE SRCNX-R INSTALLATION GUIDE

SRCNX-R READER CONTROLLER CONFIGURATION

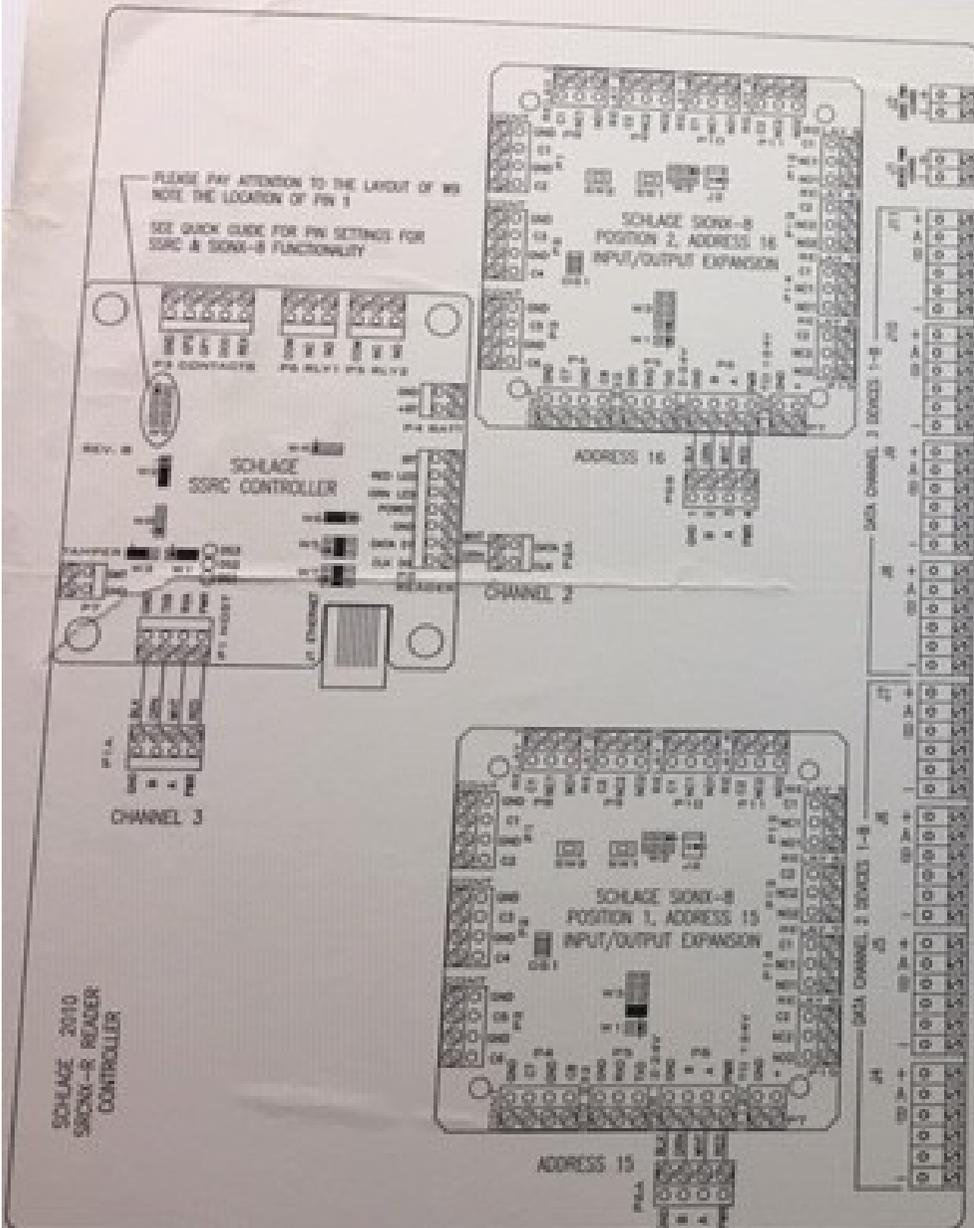

PLEASE PAY ATTENTION TO THE LAYOUT OF W1
NOTE THE LOCATION OF PW 1

SEE QUICK GUIDE FOR PW SETTINGS FOR
SRC & SORX-R FUNCTIONALITY

SCHLAGE 2010
SRCNX-R READER
CONTROLLER

↑ SIGNAL DESIGNATES PW 1 ON CONNECTOR

SCHLAGE GENERAL INFORMATION

WIRING GUIDE

REQUIREMENT: WIRE TO THE POWER CONNECTION AS IN
FIG. 1. ALL WIRE SHOULD BE WELDED TO THE EQUIPMENT.

PLEASE REFER TO WIRE CONNECTIONS FROM THE
TERMINAL BLOCKS.

WIRING GUIDE

CONNECTIONS TO THE POWER SUPPLY
CONNECTIONS TO THE DATA CHANNELS
CONNECTIONS TO THE RELAYS AND CONTACTS
CONNECTIONS TO THE RELAYS AND CONTACTS
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GENERAL INFORMATION NOTE

WIRE CONNECTIONS TO THE RELAYS AND CONTACTS
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SCHLAGE SRCNX-R READER CONTROLLER SETTINGS

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W1 - RELAY CONTACTS FOR CHANNEL 1
W2 - RELAY CONTACTS FOR CHANNEL 2
W3 - RELAY CONTACTS FOR CHANNEL 3
W4 - RELAY CONTACTS FOR CHANNEL 4
W5 - RELAY CONTACTS FOR CHANNEL 5
W6 - RELAY CONTACTS FOR CHANNEL 6
W7 - RELAY CONTACTS FOR CHANNEL 7
W8 - RELAY CONTACTS FOR CHANNEL 8

W1 - RELAY CONTACTS FOR CHANNEL 1

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W2 - RELAY CONTACTS FOR CHANNEL 2
W3 - RELAY CONTACTS FOR CHANNEL 3
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W7 - RELAY CONTACTS FOR CHANNEL 7
W8 - RELAY CONTACTS FOR CHANNEL 8

SCHLAGE SRCNX-R READER CONTROLLER

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W6 - RELAY CONTACTS FOR CHANNEL 6
W7 - RELAY CONTACTS FOR CHANNEL 7
W8 - RELAY CONTACTS FOR CHANNEL 8

W2 - RELAY CONTACTS FOR CHANNEL 2

W1 - RELAY CONTACTS FOR CHANNEL 1
W2 - RELAY CONTACTS FOR CHANNEL 2
W3 - RELAY CONTACTS FOR CHANNEL 3
W4 - RELAY CONTACTS FOR CHANNEL 4
W5 - RELAY CONTACTS FOR CHANNEL 5
W6 - RELAY CONTACTS FOR CHANNEL 6
W7 - RELAY CONTACTS FOR CHANNEL 7
W8 - RELAY CONTACTS FOR CHANNEL 8

SCHLAGE SORX-R

SCHLAGE SORX-R READER CONTROLLER SETTINGS

W1 - RELAY CONTACTS FOR CHANNEL 1
W2 - RELAY CONTACTS FOR CHANNEL 2
W3 - RELAY CONTACTS FOR CHANNEL 3
W4 - RELAY CONTACTS FOR CHANNEL 4
W5 - RELAY CONTACTS FOR CHANNEL 5
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W7 - RELAY CONTACTS FOR CHANNEL 7
W8 - RELAY CONTACTS FOR CHANNEL 8

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W7 - RELAY CONTACTS FOR CHANNEL 7
W8 - RELAY CONTACTS FOR CHANNEL 8

16 - READERS INSTALLED

WIRE CONNECTIONS TO THE RELAYS AND CONTACTS
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W1 - RELAY CONTACTS FOR CHANNEL 1
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W7 - RELAY CONTACTS FOR CHANNEL 7
W8 - RELAY CONTACTS FOR CHANNEL 8